



Wood Environment & Infrastructure Solutions, Inc.
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Kennesaw, Georgia 30144
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May 29, 2020

Mr. Paul Tobler
Georgia Department of Natural Resources
Coastal Resources Division
One Conservation Way
Brunswick, Georgia 31520

**Re: Letter of Permission for Landfill Closure
Former T Street Landfill
Brunswick, Georgia
Wood Project 6123191266**

Dear Mr. Tobler,

Per our conversation with you and the Georgia Environmental Protection Division (EPD) team on March 10, 2020, the attached updated T Street Landfill Closure Plans are being provided to Georgia EPD and the Georgia Coastal Resources Division (CRD). Wood Environment & Infrastructure Solutions, Inc. (Wood) is requesting a Letter of Permission (LOP) on behalf of our client, the T Street Landfill Steering Group (Georgia-Pacific, LLC, Hercules, LLC, and the City of Brunswick), to authorize activities associated with the closure of the Former T Street Landfill in Brunswick, Georgia.

The attached Closure Plans incorporate the changes requested by EPD and CRD during the March 10, 2020 call. (Attachment 1). Additionally, the T Street Landfill Steering Group has provided a marsh line topographic survey and a marsh debris assessment to EPD and CRD. The topographic survey and debris assessment are also included as Attachment 2 to this letter.

Based on our discussions with you and the EPD team, we understand that the project does not require a revocable license request, but CRD requests that a LOP be obtained prior to initiating work at the site. This submittal serves as our request for a LOP on behalf of the T Street Landfill Steering Group. The timeframe for proposed work within the marsh buffer is July through September 2020.

If you have any questions regarding this submittal, please contact Heidi Fogell at (770) 421-3387 or Dan Grogan at (770) 547-7141. Wood looks forward to the opportunity to continue to assist the T Street Landfill Steering Group with this very important project to expedite final closure.

Sincerely,

Wood Environment & Infrastructure Solutions, Inc.

Jonathan A. Bourdeau, PWS
Senior Scientist 1

Heidi E. Fogell, FP-C
Associate Project Manager




CC: Ms. Jill Andrews, CRD
Mr. Bill Williams, EPD
Ms. Shannon Betts, Georgia-Pacific, LLC
Mr. Tim Hassett, Hercules, LLC
Mr. Garrow Alberson, City of Brunswick



ATTACHMENT 1 – T STREET LANDFILL CLOSURE PLANS



**T STREET LANDFILL STEERING GROUP
GLYNN COUNTY
BRUNSWICK, GEORGIA**

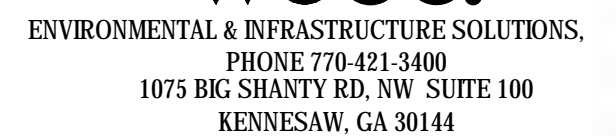

NO	DATE	REVISIONS	BY	AP.	NO	DATE	REVISIONS	BY	AP.	NOTICE This drawing has not been published and is the sole property of T STREET LANDFILL STEERING GROUP and is lent to the borrower for their confidential use only; and in consideration of the loan of this drawing the borrower promises and agrees that it shall not be reproduced, copied, lent or otherwise disposed of directly or indirectly, nor used for any purpose other than for which it is specifically furnished.	DWG. NO.	REFERENCE DRAWINGS	T STREET LANDFILL CLOSURE GLYNN COUNTY BRUNSWICK, GA		COVER SHEET			
0	20MAY20	ISSUED FOR CONSTRUCTION	LKR	PWM														
A	07MAY20	FOR OWNER REVIEW	LKR	PWM														
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48	ES&PC CHECKLIST	C-504
49	ES&PC NOTES	C-601
50	ES&PC NOTES	C-602
51	ES&PC NOTES	C-603

SHEET ENLARGEMENTS

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C-104 EXISTING CONDITIONS & DEMOLITION PLAN C-204 SITE PLAN C-304 GRADING PLAN C-404 PHASE I EROSION CONTROL PLAN C-410 PHASE II EROSION CONTROL PLAN C-416 PHASE III EROSION CONTROL PLAN	C-105 EXISTING CONDITIONS & DEMOLITION PLAN C-205 SITE PLAN C-305 GRADING PLAN C-405 PHASE I EROSION CONTROL PLAN C-411 PHASE II EROSION CONTROL PLAN C-417 PHASE III EROSION CONTROL PLAN	C-106 EXISTING CONDITIONS & DEMOLITION PLAN C-206 SITE PLAN C-306 GRADING PLAN C-406 PHASE I EROSION CONTROL PLAN C-412 PHASE II EROSION CONTROL PLAN C-418 PHASE III EROSION CONTROL PLAN

GENERAL NOTES:

1. CONTRACTOR SHALL BE RESPONSIBLE FOR VERIFYING SITE CONDITIONS AND LOCATIONS OF ALL UTILITIES. COORDINATE WITH ALL UTILITY COMPANIES. NO ADDITIONAL PAYMENT SHALL BE ALLOWED DUE TO REQUIRED LINE RELOCATION HORIZONTALLY OR NEED TO INCREASE DEPTH DUE TO UTILITIES OR SITE CONDITIONS.
2. NOTE THE PROXIMITY OF POWER POLES IN RELATIONSHIP TO THE PROJECT. CONTRACTOR SHALL BE RESPONSIBLE FOR PROTECTING POWER POLES AND GUY WIRES DURING CONSTRUCTION. COORDINATE WITH UTILITY POLE OWNERS.
3. THE CONTRACTOR SHALL REVIEW AND VERIFY ALL DIMENSIONS SHOWN ON THE PLANS AND REVIEW ALL FIELD CONDITIONS THAT MAY AFFECT CONSTRUCTION. SHOULD DISCREPANCIES OCCUR, THE CONTRACTOR SHALL NOTIFY THE ENGINEER TO OBTAIN THE ENGINEER'S CLARIFICATION BEFORE COMMENCING CONSTRUCTION.
4. THE ENGINEER RESERVES THE RIGHT TO ADJUST THE LOCATION OF ALL PROPOSED IMPROVEMENTS TO MEET FIELD CONDITIONS IF NECESSARY.
5. THE CONTRACTOR SHALL BE RESPONSIBLE FOR LOCATING ALL EXISTING STRUCTURES, UTILITIES AND SERVICES PRIOR TO EXCAVATION AND CONSTRUCTION.
6. THE CONTRACTOR SHALL PROTECT ALL EXISTING STRUCTURES, STORM DRAINS, UTILITIES AND OTHER FACILITIES TO REMAIN AND SHALL REPAIR ANY DAMAGES DUE TO CONSTRUCTION ACTIVITIES AT NO ADDITIONAL COST TO THE OWNER.
7. THE CONTRACTOR SHALL USE ALL NECESSARY SAFETY PRECAUTIONS TO AVOID CONTACT WITH OVERHEAD AND UNDERGROUND POWER LINES.
8. THE CONTRACTOR SHALL MAINTAIN ACCESS TO ALL PRIVATE AND COMMERCIAL PROPERTIES THROUGHOUT THE DURATION OF THE PROJECT. THE CONTRACTOR SHALL DETOUR TRAFFIC AWAY FROM OPEN EXCAVATIONS AND SHALL PROVIDE SAFE, EXPEDITIOUS VEHICULAR MOVEMENT THROUGH CONSTRUCTION ZONES.
9. PROVIDE SHORING, SHEETING AND BRACING, AS NEEDED, IN CONFORMANCE WITH THE APPLICABLE RULES AND REGULATIONS PROMULGATED BY THE DEPARTMENT OF LABOR, OCCUPATIONAL SAFETY AND HEALTH ADMINISTRATION, "SAFETY AND HEALTH REGULATIONS FOR CONSTRUCTION".
10. LAND DISTURBANCE ACTIVITIES ASSOCIATED WITH THE WORK COULD UNCOVER PREVIOUSLY UNKNOWN ARCHAEOLOGICAL MATERIAL. IF SUCH MATERIAL IS DISCOVERED PRIOR TO OR DURING THE LAND DISTURBANCE ACTIVITIES, OR IF IT IS SUSPECTED THAT SUCH MATERIAL IS PRESENT, THE CONTRACTOR SHALL IMMEDIATELY CEASE LAND DISTURBANCE ACTIVITIES IN THE VICINITY OF THE FND AND PROMPTLY NOTIFY THE ENGINEER. ALL ARCHAEOLOGICAL MATERIAL FOUND SHALL BECOME THE PROPERTY OF THE OWNER. (THE ENGINEER WILL IMMEDIATELY NOTIFY THE STATE HISTORIC PRESERVATION OFFICER.)
11. PRESERVE AND PROTECT MONITORING WELLS AND BENCHMARKS. DAMAGED WELLS AND BENCHMARK MONUMENTS SHALL BE REPAIRED BY THE OWNER AT THE CONTRACTOR'S EXPENSE.
12. CONTRACTOR HAUL ROADS SHALL NOT IMPEDE SURFACE WATER FLOW. PROVIDE CULVERTS, DITCHING, ETC. TO MAINTAIN POSITIVE DRAINAGE.
13. DEBRIS LOCATED OUTSIDE OF THE LANDFILL LIMITS SHALL BE MOVED WITHIN THE LIMITS OF CONSTRUCTION DISTURBANCE PRIOR TO THE START OF GRADING OPERATIONS.

LEGEND

ITEM	SYMBOL
APPROXIMATE 25' MARSH BUFFER	
CRD LINE DELINEATED JULY1, 2019 BY RESOURCE AND LAND CONSULTANTS	
5.6' MEAN TIDE LEVEL LINE	
PROPERTY LINE	
APPROXIMATE LIMITS OF EX LANDFILL AS PREPARED BY RMT	
VEGETATION LIMITS	
EXISTING OVERHEAD POWER LINES	
EXISTING CHAIN LINK FENCE	
EXISTING LANDFILL DEBRIS	
EXISTING MAJOR CONTOURS	
EXISTING MINOR CONTOURS	
EXISTING POWER POLE	
EXISTING LIGHT POLE	
EXISTING GUY POLE	
PROPOSED DETAIL REFERENCE	
PROPOSED COORDINATE	
PROPOSED RADIAL POINT	
PROPOSED MAJOR FINISH GRADE CONTOURS	
PROPOSED MINOR FINISH GRADE CONTOURS	
PROPOSED LIMITS OF DISTURBANCE	
PROPOSED CHAIN LINK FENCE	
25' WETLAND BUFFER	
PROPOSED GRAVEL ACCESS ROAD	
EXISTING ASPHALT ROAD	
EXISTING GRAVEL ROAD	
EXISTING DIRT ROAD	

ACRONYMS


ITEM	SYMBOL
N.T.S.	NOT TO SCALE
DEQ	DEPARTMENT OF ENVIRONMENTAL QUALITY
RP	RADIAL POINT
ES&PC	EROSION, SEDIMENTATION & POLLUTION CONTROL

SURVEY NOTES:

1. THE TOPOGRAPHIC INFORMATION SHOWN IN THESE PLANS WAS PROVIDED TO WOOD BY EMC ENGINEERING SERVICES AND IS DATED AUGUST 29, 2019.
2. WOOD DOES NOT WARRANT THE ACCURACY OF THIS INFORMATION. IT IS THE CONTRACTOR'S RESPONSIBILITY TO SATISFY HIMSELF OF THE ACCURACY OF THIS INFORMATION PRIOR TO COMMENCING CONSTRUCTION.
3. THE WETLAND BUFFER AS SHOWN IN THE PLANS SHALL HAVE A MINIMUM WIDTH OF 25'.
4. THE INFORMATION SHOWN IN THE PLANS MIGHT REFLECT WORK THAT HAS ALREADY BEEN PERFORMED BY THE CONTRACTOR. IT IS THE CONTRACTOR'S RESPONSIBILITY TO SATISFY HIMSELF AS TO THE ACCURACY OF THE INFORMATION SHOWN PRIOR TO THE COMMENCEMENT OF CONSTRUCTION.

NO	DATE	REVISIONS	BY	AP.	NO	DATE	REVISIONS	BY	AP.	NOTICE	DWG. NO.	REFERENCE DRAWINGS	<i>T STREET LANDFILL CLOSURE</i>			GENERAL NOTES & INDEX																					
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														BRUNSWICK, GA			DR.		W. O.		DWG. NO.		REV.														
																	CH.				6123-20-1372-G-002		----														
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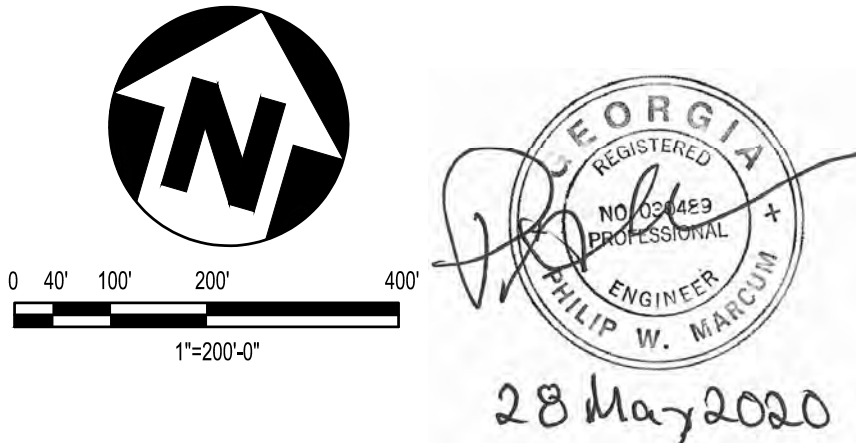


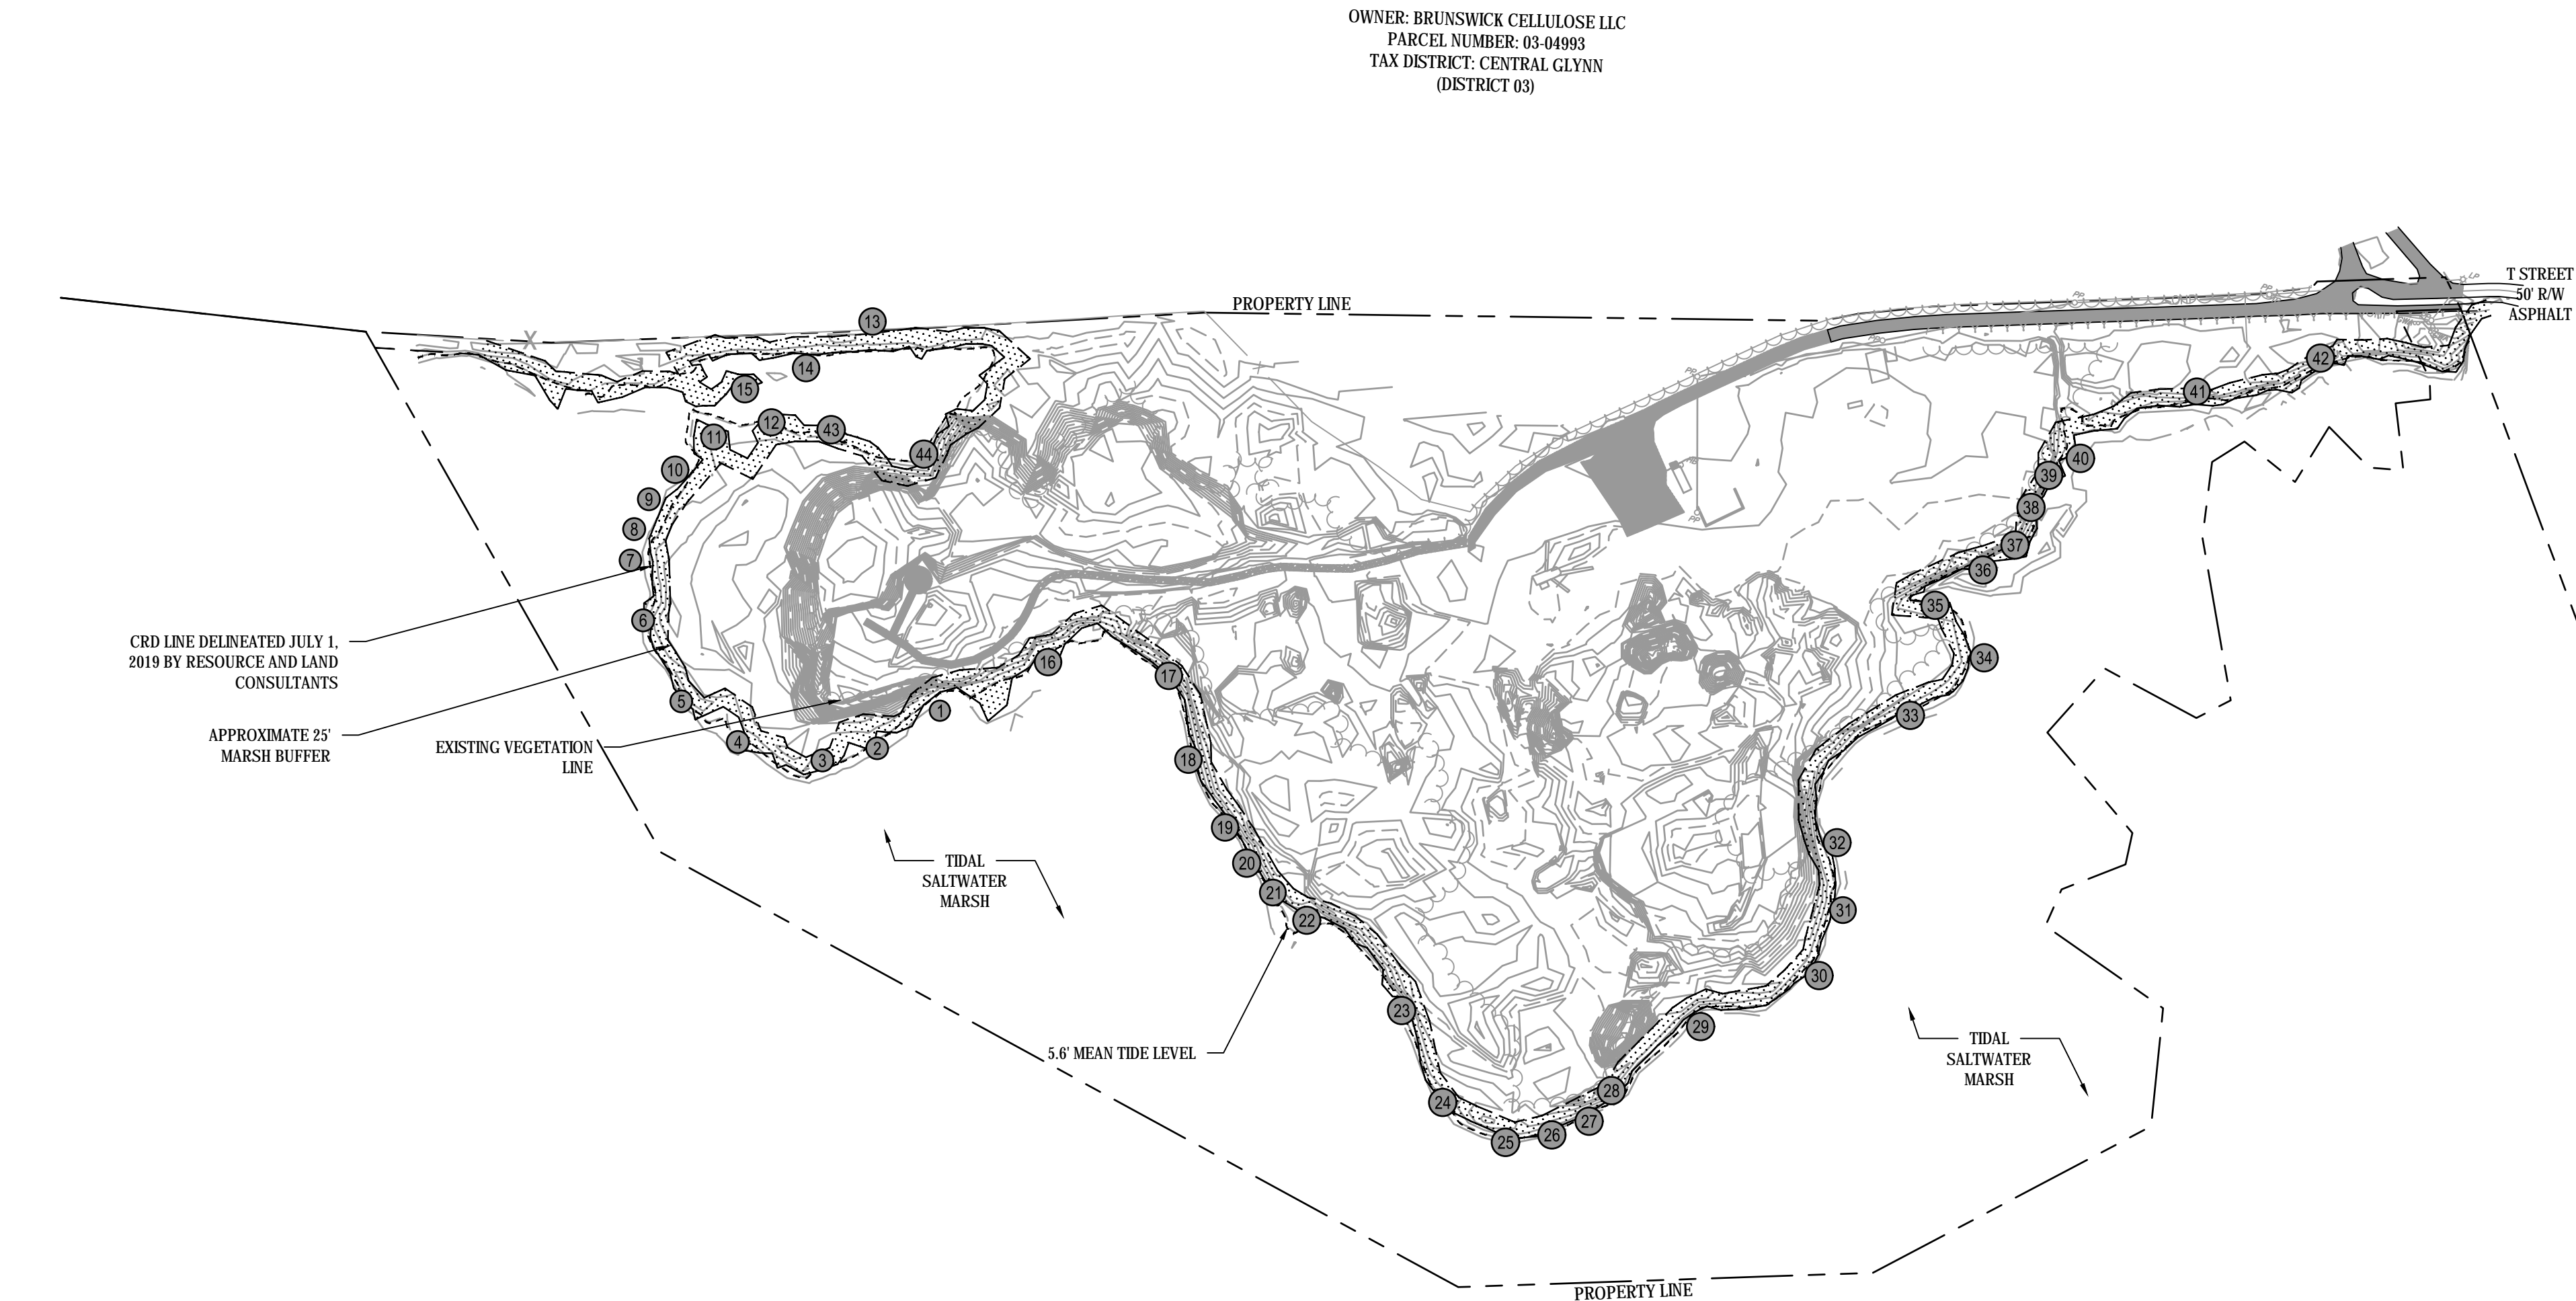

DEBRIS REMOVAL NOTES

- DEBRIS REMOVAL WITHIN THE 25-FOOT MARSH BUFFER WILL FOLLOW GUIDANCE PROVIDED IN THE FEBRUARY 25, 2020 "MARSH DEBRIS ASSESSMENT REPORT", PREPARED BY WOOD E&S.
- MACHINERY OPERATION AND DEBRIS REMOVAL WITHIN THE BUFFER CAN OCCUR AS LONG AS VEGETATION IS NOT REMOVED, GROUND SURFACE DISTURBANCE RESULTING FROM REMOVAL OF DEBRIS IS MINIMIZED, AND EROSION AND SEDIMENT CONTROL FENCING IS REPLACED AS SOON AS PRACTICABLE AFTER ACCESS.
- WHERE AREAS EITHER CONTAIN INERT MATERIALS (CONCRETE) THAT SERVE TO PROTECT THE LANDFILL BASE FROM TIDAL EROSION, OR ARE HINDERED BY ACCESS OR DISTURBANCE AND/OR WOULD REQUIRE CLEARING PORTIONS OF THE VEGETATIVE BUFFER, DEBRIS WOULD BE LEFT IN PLACE AND THE AREA WOULD BE HAND-CLEARED OR CLEARED FROM OUTSIDE THE 25-FOOT BUFFER AS IS FEASIBLE.
- NO MACHINERY OPERATION WILL OCCUR WITHIN MARSH AREAS, EXCEPT AS INDICATED IN THE "MARSH DEBRIS ASSESSMENT REPORT".
- DEBRIS FROM THE 25-FOOT MARSH BUFFER WOULD BE RELOCATED INTO THE LANDFILL OUTSIDE OF THE BUFFER.


Location Number	Debris Description
1	Concrete, tires, asphalt, bricks, metal
2	Railroad ties, few roofing tiles, MSW
3	Tires, metal bed frame
4	Concrete rubble, bricks, asphalt, few pieces of metal debris
5	Metal, asphalt, concrete
6	Railroad ties, concrete, culvert rubble, asphalt
7	Railroad ties, concrete, asphalt
8	Woody debris (railroad ties, poles), concrete (includes 8, 7, 6)
9	Woody debris (railroad ties, poles), concrete
10	Asphalt, brick, metal, rubber, MSW
11	Concrete, brick, tires, roofing tiles
12	Tires, metal, MSW
13	Concrete, metal, brick, MSW
14	Metal car parts, tires, MSW
15	Metal, MSW
16	Concrete, MSW
17	Woody debris, tires, concrete, tank
18	Concrete, MSW
19	Concrete, appliance, MSW
20	Concrete, MSW
21	Concrete, asphalt, MSW
22	Concrete, MSW
23	Concrete, asphalt, metal
24	Tires, metal, MSW
25	Concrete, tires, metal, saphaly
26	Concrete, brick, MSW
27	Concrete, MSW
28	MSW
29	Concrete, asphalt, tires, culverts, railroad ties, MSW
30	Concrete, asphalt, MSW
31	Concrete, MSW
32	Metal tanks, piping
33	MSW, one auto battery
34	Concrete, woody debris, MSW
35	Concrete, asphalt, metal, MSW
36	Metal, MSW
37	Concrete, brick, railroad ties, rebar, MSW
38	Metal-sided trailer in wetland
39	Concrete, MSW
40	Concrete, tires, appliance, MSW
41	MSW, filter cake material
42	Tires, MSW
43	No debris
44	Filter cake material



28 May 2020

NO	DATE	REVISIONS	BY	AP.	NO	DATE	REVISIONS	BY	AP.	NOTICE	DWG. NO.	REFERENCE DRAWINGS	<i>T STREET LANDFILL CLOSURE</i>			DEBRIS LOCATION MAP			
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1. THE CONTRACTOR SHALL PERFORM TREE AND BRUSH CLEARING AND GRUBBING UP TO THE PROPOSED LIMITS OF DISTURBANCE AS SHOWN ON THE ES&PC PLANS. A MINIMUM 30' WIDE WOODED BUFFER WILL BE LEFT IN PLACE WHERE ACHIEVABLE.
2. ALL METAL CONSTRUCTION AND DEMOLITION DEBRIS SHALL BE HAULED OFFSITE AND DISPOSED/RECYCLED BY THE CONTRACTOR IN ACCORDANCE WITH LOCAL, STATE, AND FEDERAL REQUIREMENTS.
3. THE CONTRACTOR IS RESPONSIBLE FOR CONTACTING THE APPROPRIATE UTILITY AUTHORITIES FOR APPROVAL PRIOR TO REMOVING POWER POLES, POWER LINES, WATER SERVICES AND CONNECTIONS.
4. THE CONTRACTOR IS RESPONSIBLE FOR MANAGING WOOD DEBRIS GENERATED FROM CLEARING OR EXISTING PILES ONSITE. WOOD DEBRIS SHALL EITHER BE MULCHED FOR USE TO MEET THE GRADES SHOWN ON THIS SHEET OR HAULED OFFSITE FOR DISPOSAL IN ACCORDANCE WITH LOCAL, STATE AND FEDERAL REQUIREMENTS.
5. GENERAL FILL SUPPLIED BY THE CONTRACTOR SHALL BE USED TO MEET THE GRADES SHOWN ON THIS SHEET WHERE NECESSARY.
6. THE CONTRACTOR SHALL HAVE THE LANDFILL AREA SURVEYED FOLLOWING REGRADE AND PRIOR TO PLACEMENT OF FINAL COVER MATERIAL TO ENSURE THAT A MINIMUM OF 2 FEET OF COVER MATERIAL IS INSTALLED.
7. THE CONTRACTOR SHALL DEMOLISH AND REMOVE ALL BUILDINGS, EQUIPMENT, CONVEYOR SYSTEMS, TRAILERS, AND ANY OTHER METAL STRUCTURES PRESENT AT THE SITE AT THE TIME OF CONSTRUCTION COMMENCES. ALL METAL STRUCTURES PRESENT AT THE SITE AT THE TIME CONSTRUCTION COMMENCES
8. THE CONTRACTOR SHALL CRUSH ASPHALT AND CONCRETE CONSTRUCTION AND DEMOLITION DEBRIS TO WORKABLE SIZE IN ORDER TO USE FOR GRADING TO MEET THE GRADES SHOWN ON THE GRADING PLAN
9. EXISTING GRAVEL AND DIRT ROAD SHALL BE REMOVED AND DISPOSED OF OFF SITE
10. ALL POWER POLES, POWER LINES, LIGHT POLES, AND TELEPHONE PEDESTALS SHALL BE REMOVED FROM WITHIN THE LIMITS OF CONSTRUCTION BY THE CONTRACTOR
11. ALL WATER SERVICE AND HIGH PRESSURE SHALL BE REMOVED FROM WITHIN THE LIMITS OF CONSTRUCTION BY THE CONTRACTOR
12. TOTES, TANKS, AND CONTAINERS SHALL BE REMOVED FROM THE SITE BY THE CONTRACTOR AND DISPOSED OF IN ACCORDANCE WITH LOCAL, STATE, AND FEDERAL REQUIREMENTS PRIOR TO PERFORMING ANY GRADING WORK IN THE AREAS WHERE THESE OBJECTS ARE PRESENT
13. EXISTING CHAIN LINK FENCE SHALL BE REMOVED FROM WITHIN THE LIMITS OF CONSTRUCTION BY THE CONTRACTOR
14. THE EXISTING INFORMATION SHOWN IN THE PLANS MIGHT REFLECT WORK THAT HAS ALREADY BEEN PERFORMED BY THE CONTRACTOR. IT IS THE CONTRACTOR'S RESPONSIBILITY TO SATISFY HIMSELF AS TO THE ACCURACY OF THE INFORMATION SHOWN PRIOR TO THE COMMENCEMENT OF CONSTRUCTION.

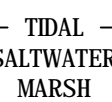


0' 40' 100' 200' 400'



1"=200'-0"

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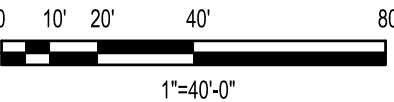
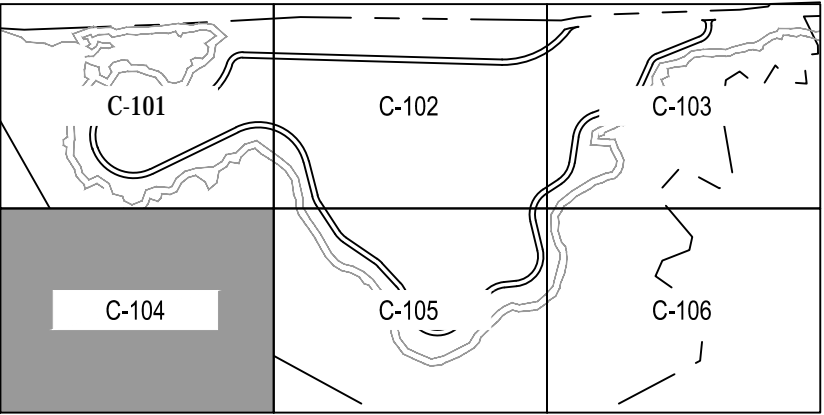
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		BRUNSWICK, GA

EXISTING CONDITIONS & DEMOLITION PLAN			
ENG. LKR	JOB NO. 6123-20-1372	DATE 05/19/2020	
DR.	W. O.	DWG. NO.	REV.
CH.		6123-20-1372-C-101	----
AP. PWM			

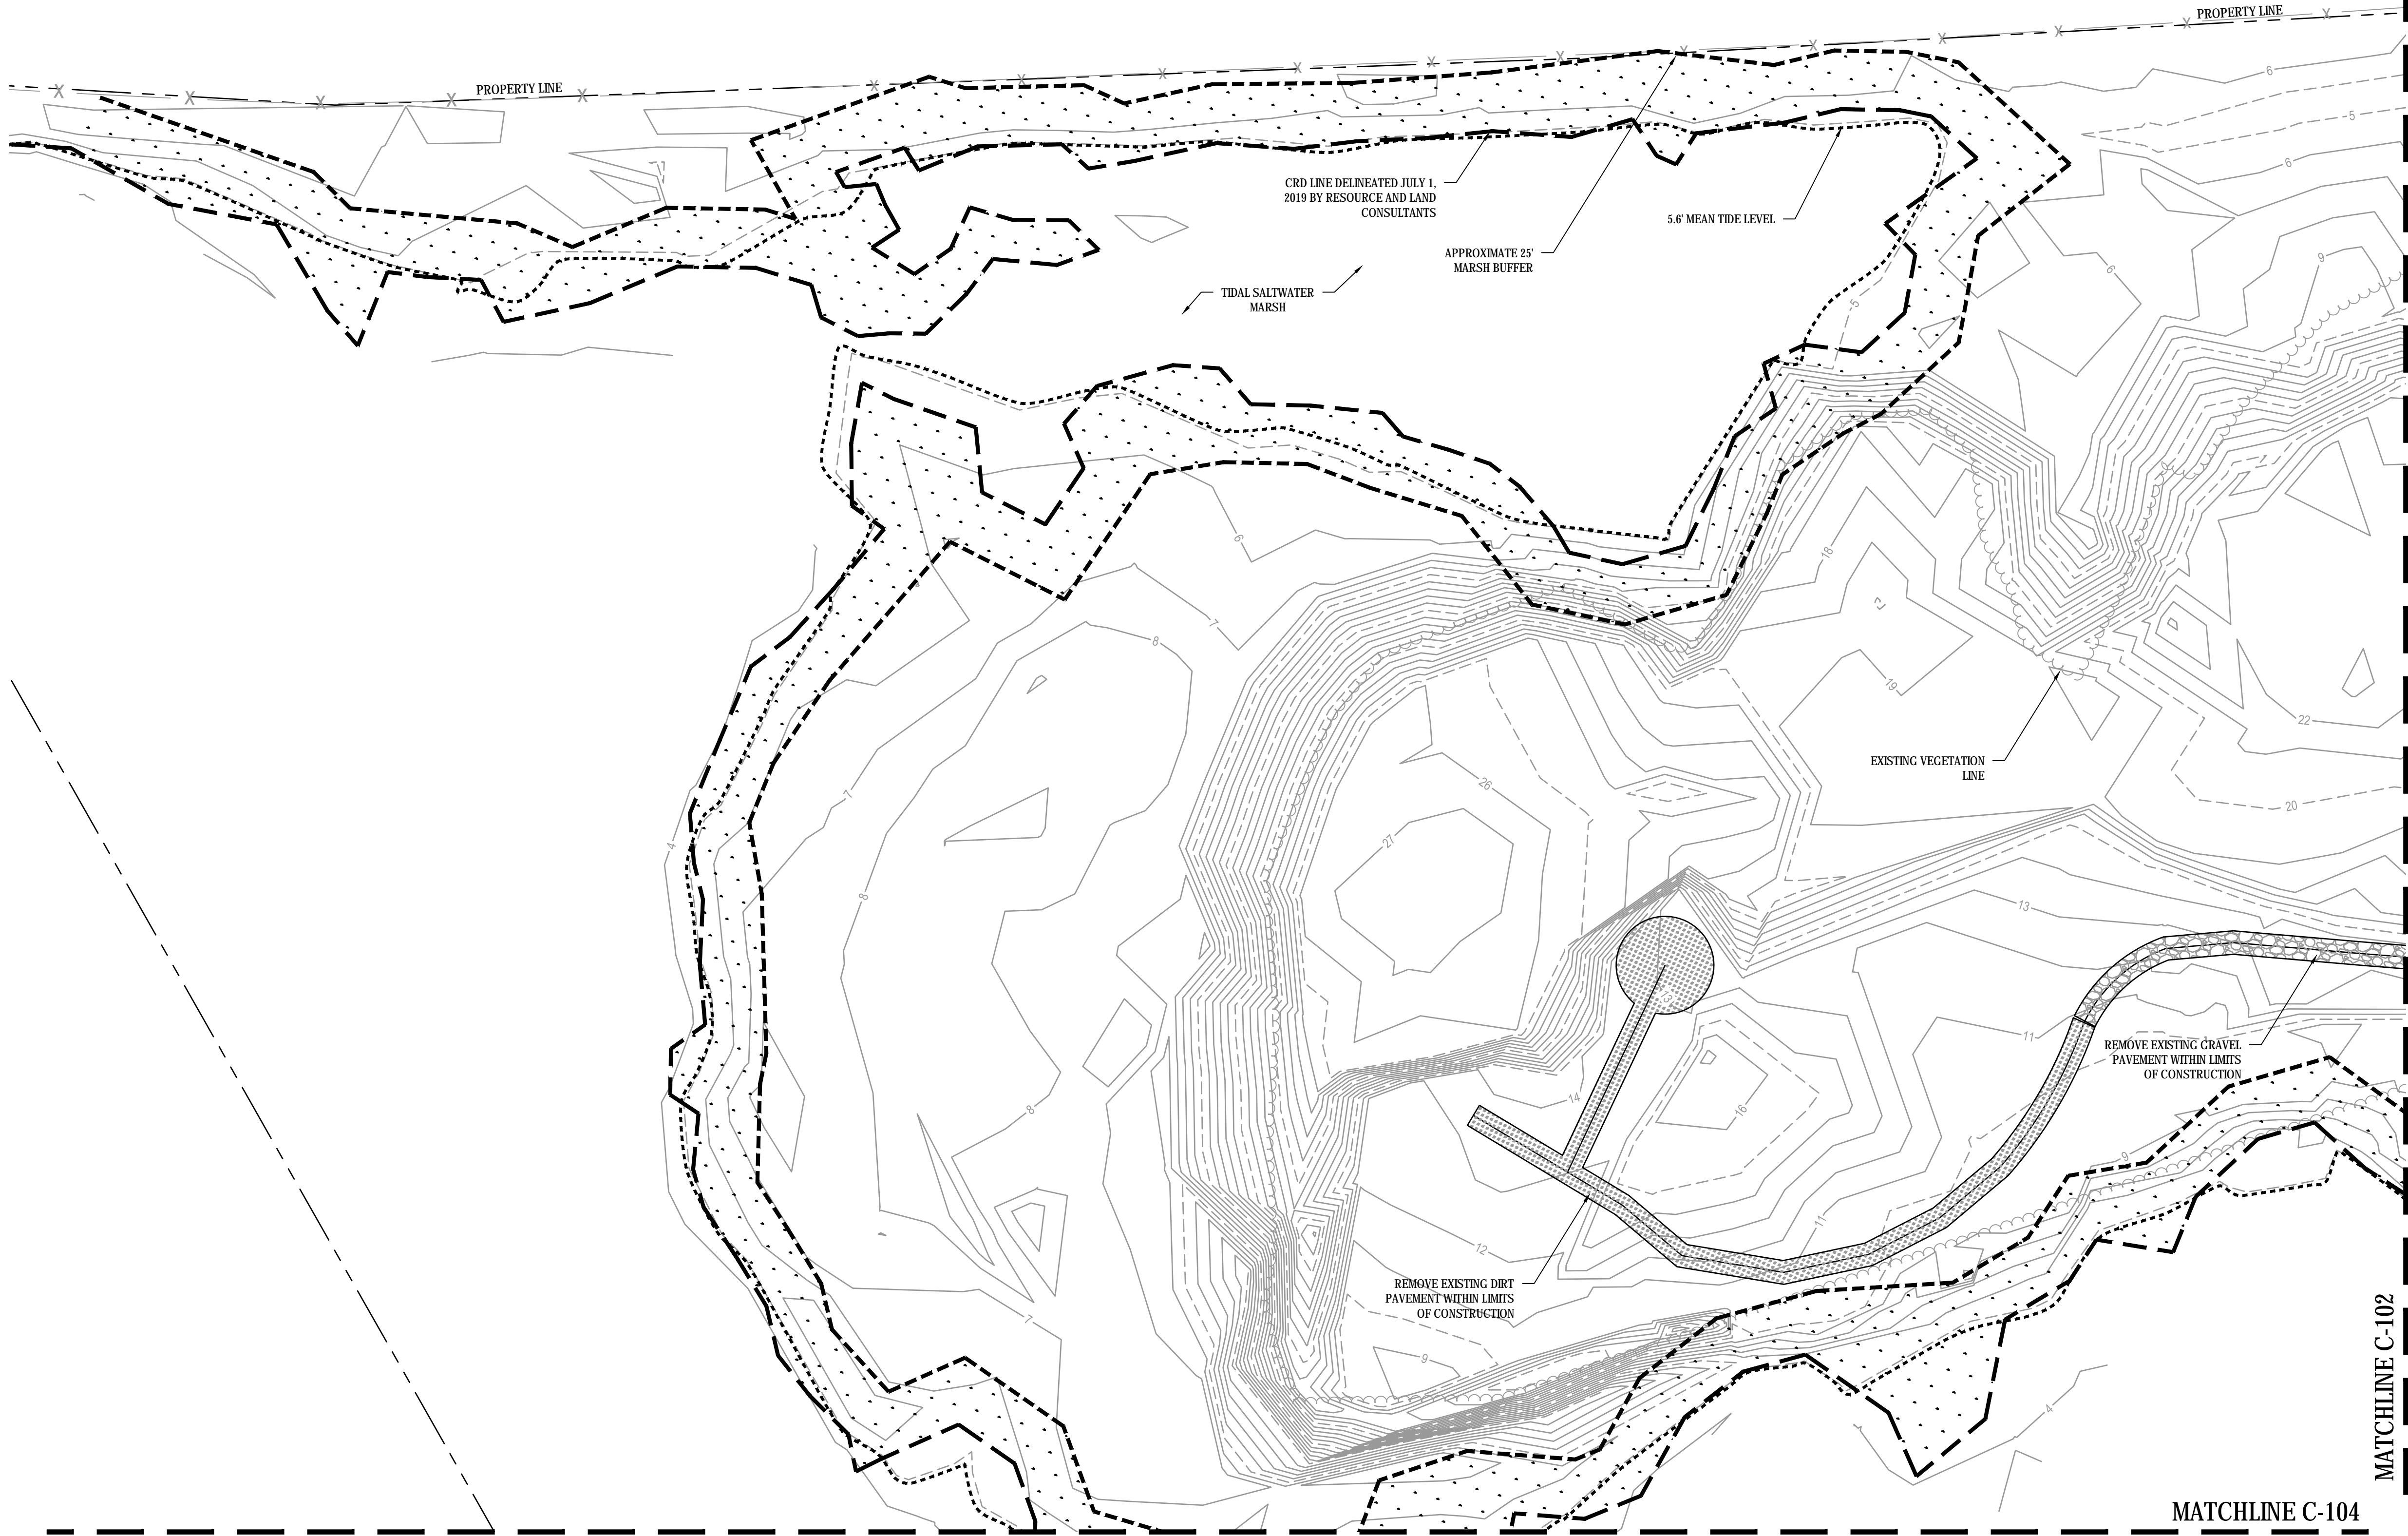MATCHLINE C-101

MATCHLINE C-105

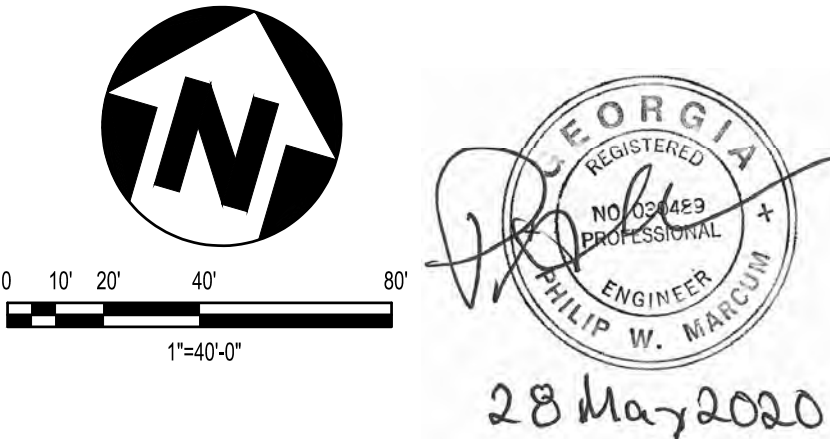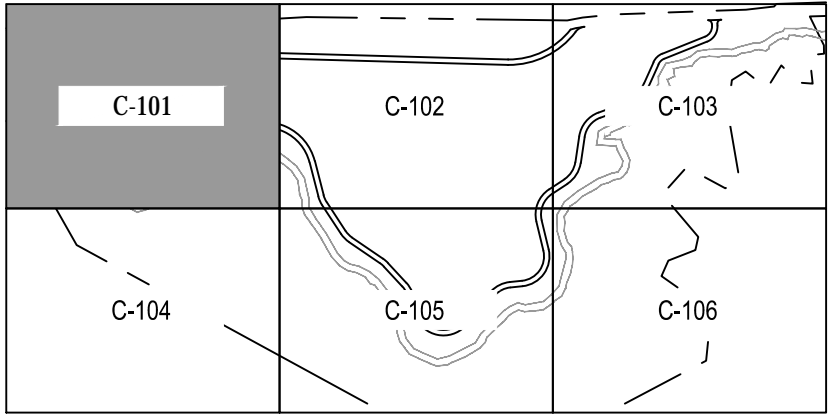- GENERAL DEMOLITION NOTES
1. THE CONTRACTOR SHALL PERFORM TREE AND BRUSH CLEARING AND GRUBBING UP TO THE PROPOSED LIMITS OF DISTURBANCE AS SHOWN ON THE ES&PC PLANS. A MINIMUM 30' WIDE WOODED BUFFER WILL BE LEFT IN PLACE WHERE ACHIEVABLE.
 2. ALL METAL CONSTRUCTION AND DEMOLITION DEBRIS SHALL BE HAULED OFFSITE AND DISPOSED/RECYCLED BY THE CONTRACTOR IN ACCORDANCE WITH LOCAL, STATE, AND FEDERAL REQUIREMENTS.
 3. THE CONTRACTOR IS RESPONSIBLE FOR CONTACTING THE APPROPRIATE UTILITY AUTHORITIES FOR APPROVAL PRIOR TO REMOVING POWER POLES, POWER LINES, WATER SERVICES AND CONNECTIONS.
 4. THE CONTRACTOR IS RESPONSIBLE FOR MANAGING WOOD DEBRIS GENERATED FROM CLEARING OR EXISTING PILES ONSITE. WOOD DEBRIS SHALL EITHER BE MULCHED FOR USE TO MEET THE GRADES SHOWN ON THIS SHEET OR HAULED OFFSITE FOR DISPOSAL IN ACCORDANCE WITH LOCAL, STATE AND FEDERAL REQUIREMENTS.
 5. GENERAL FILL SUPPLIED BY THE CONTRACTOR SHALL BE USED TO MEET THE GRADES SHOWN ON THIS SHEET WHERE NECESSARY.
 6. THE CONTRACTOR SHALL HAVE THE LANDFILL AREA SURVEYED FOLLOWING REGRADING AND PRIOR TO PLACEMENT OF FINAL COVER MATERIAL TO ENSURE THAT A MINIMUM OF 2 FEET OF COVER MATERIAL IS INSTALLED.
 7. THE CONTRACTOR SHALL DEMOLISH AND REMOVE ALL BUILDINGS, EQUIPMENT, CONVEYOR SYSTEMS, TRAILERS, AND ANY OTHER METAL STRUCTURES PRESENT AT THE SITE AT THE TIME OF CONSTRUCTION COMMENCES. ALL METAL STRUCTURES PRESENT AT THE SITE AT THE TIME CONSTRUCTION COMMENCES
 8. THE CONTRACTOR SHALL CRUSH ASPHALT AND CONCRETE CONSTRUCTION AND DEMOLITION DEBRIS TO WORKABLE SIZE IN ORDER TO USE FOR GRADING TO MEET THE GRADES SHOWN ON THE GRADING PLAN
 9. EXISTING GRAVEL AND DIRT ROAD SHALL BE REMOVED AND DISPOSED OF OFF-SITE
 10. ALL POWER POLES, POWER LINES, LIGHT POLES, AND TELEPHONE PEDESTALS SHALL BE REMOVED FROM WITHIN THE LIMITS OF CONSTRUCTION BY THE CONTRACTOR
 11. ALL WATER SERVICE AND HOSE BIBBS SHALL BE REMOVED FROM WITHIN THE LIMITS OF CONSTRUCTION BY THE CONTRACTOR
 12. TOTES, TANKS, AND CONTAINERS SHALL BE REMOVED FROM THE SITE BY THE CONTRACTOR AND DISPOSED OF IN ACCORDANCE WITH LOCAL, STATE, AND FEDERAL REQUIREMENTS PRIOR TO PERFORMING ANY GRADING WORK IN THE AREAS WHERE THESE OBJECTS ARE PRESENT
 13. EXISTING CHAIN LINK FENCE SHALL BE REMOVED FROM WITHIN THE LIMITS OF CONSTRUCTION BY THE CONTRACTOR
 14. THE EXISTING INFORMATION SHOWN IN THE PLANS MIGHT REFLECT WORK THAT HAS ALREADY BEEN PERFORMED BY THE CONTRACTOR. IT IS THE CONTRACTOR'S RESPONSIBILITY TO SATISFY HIMSELF AS TO THE ACCURACY OF THE INFORMATION SHOWN PRIOR TO THE COMMENCEMENT OF CONSTRUCTION.




NO		DATE		REVISIONS		BY	AP.	NO		DATE		REVISIONS		BY	AP.	NOTICE This drawing has not been published and is the sole property of T STREET LANDFILL STEERING GROUP and is lent to the borrower for their confidential use only; and in consideration of the loan of this drawing the borrower promises and agrees that it shall not be reproduced, copied, lent or otherwise disposed of directly or indirectly, nor used for any purpose other than for which it is specifically furnished.	DWG. NO.	REFERENCE DRAWINGS			T STREET LANDFILL CLOSURE GLYNN COUNTY BRUNSWICK, GA			EXISTING CONDITIONS & DEMOLITION PLAN													
																								ENG. LKR		JOB NO. 6123-20-1372		DATE 05/19/2020									
																								DR.		W. O.		DWG. NO.		REV. ----							
																								CH.				6123-20-1372-C-104									
																								AP. PWM													
0		20MAY20		ISSUED FOR CONSTRUCTION		LKR	PWM																														
A		07MAY20		FOR OWNER REVIEW		LKR	PWM																														
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MATCHLINE C-104

1. THE CONTRACTOR SHALL PERFORM TREE AND BRUSH CLEARING AND GRUBBING UP TO THE PROPOSED LIMITS OF DISTURBANCE AS SHOWN ON THE ES&CP PLANS. A MINIMUM 30' WIDE WOODED BUFFER WILL BE LEFT IN PLACE WHEREACHIEVABLE.
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APPROXIMATE 25'
MARSH BUFFER

PROPERTY LINE



28 May 2020

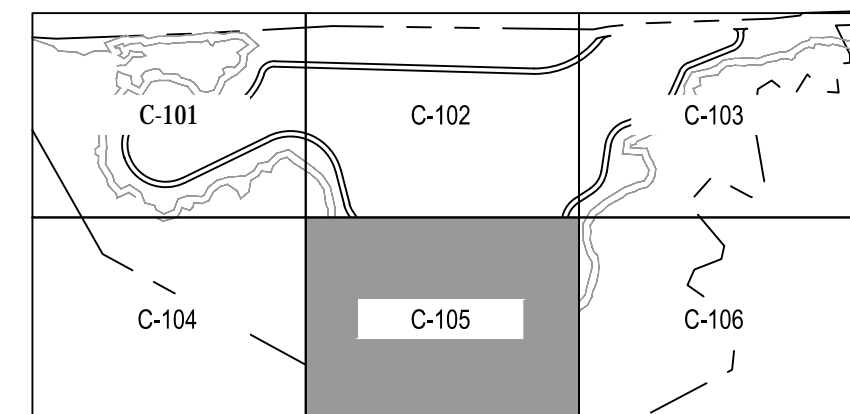NO		DATE	REVISIONS		BY	AP.	NO	DATE	REVISIONS		BY	AP.	NOTICE This drawing has not been published and is the sole property of T STREET LANDFILL STEERING GROUP and is lent to the borrower for their confidential use only; and in consideration of the loan of this drawing the borrower promises and agrees that it shall not be reproduced, copied, lent or otherwise disposed of directly or indirectly, nor used for any purpose other than for which it is specifically furnished.	DWG. NO.	REFERENCE DRAWINGS		T STREET LANDFILL CLOSURE GLYNN COUNTY BRUNSWICK, GA			EXISTING CONDITIONS & DEMOLITION PLAN																	
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MATCHLINE C-103

GENERAL DEMOLITION NOTES

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5.6' MEAN TIDE LEVEL



CRD LINE DELINEATED JULY 1, 2019 BY RESOURCE AND LAND CONSULTANTS

APPROXIMATE 25' MARSH BUFFER

PROPERTY LINE


TIDAL SALTWATER MARSH


MATCHLINE C-105

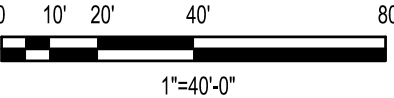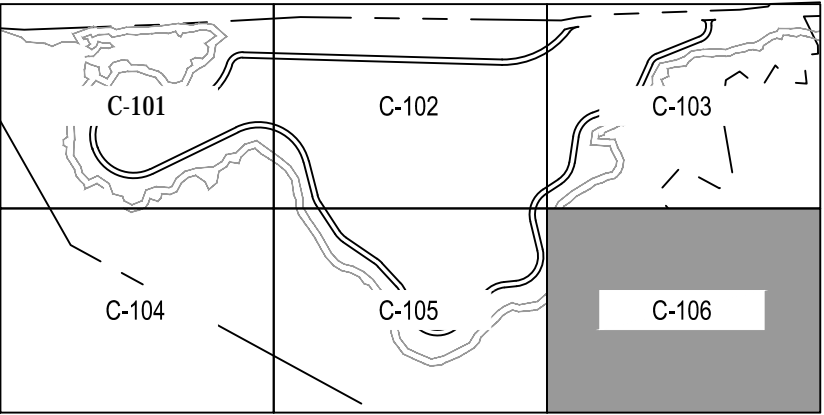


28 May 2020




NO		DATE	REVISIONS		BY	AP.	NO	DATE	REVISIONS		BY	AP.	NOTICE			DWG. NO.	REFERENCE DRAWINGS			<i>T STREET LANDFILL CLOSURE</i>			EXISTING CONDITIONS & DEMOLITION PLAN														
													This drawing has not been published and is the sole property of T STREET LANDFILL STEERING GROUP and is lent to the borrower for their confidential use only; and in consideration of the loan of this drawing the borrower promises and agrees that it shall not be reproduced, copied, lent or otherwise disposed of directly or indirectly, nor used for any purpose other than for which it is specifically furnished.				GLYNN COUNTY BRUNSWICK, GA																				
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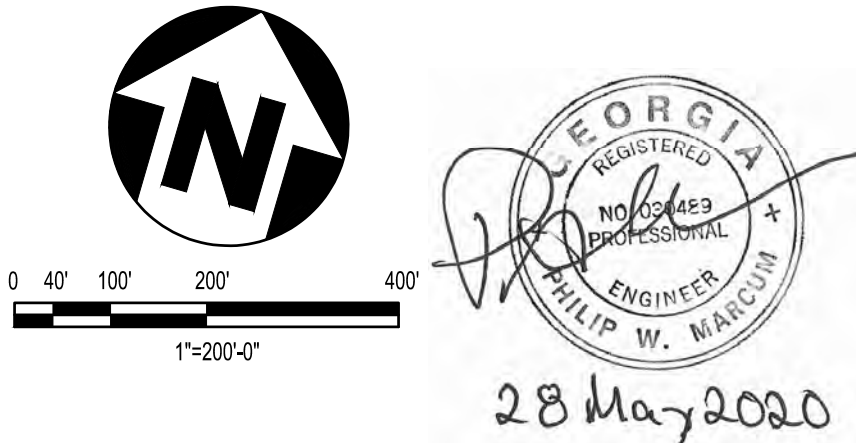
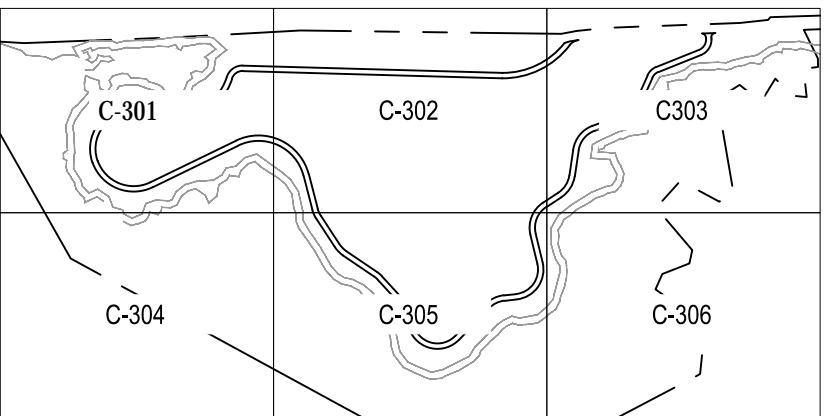


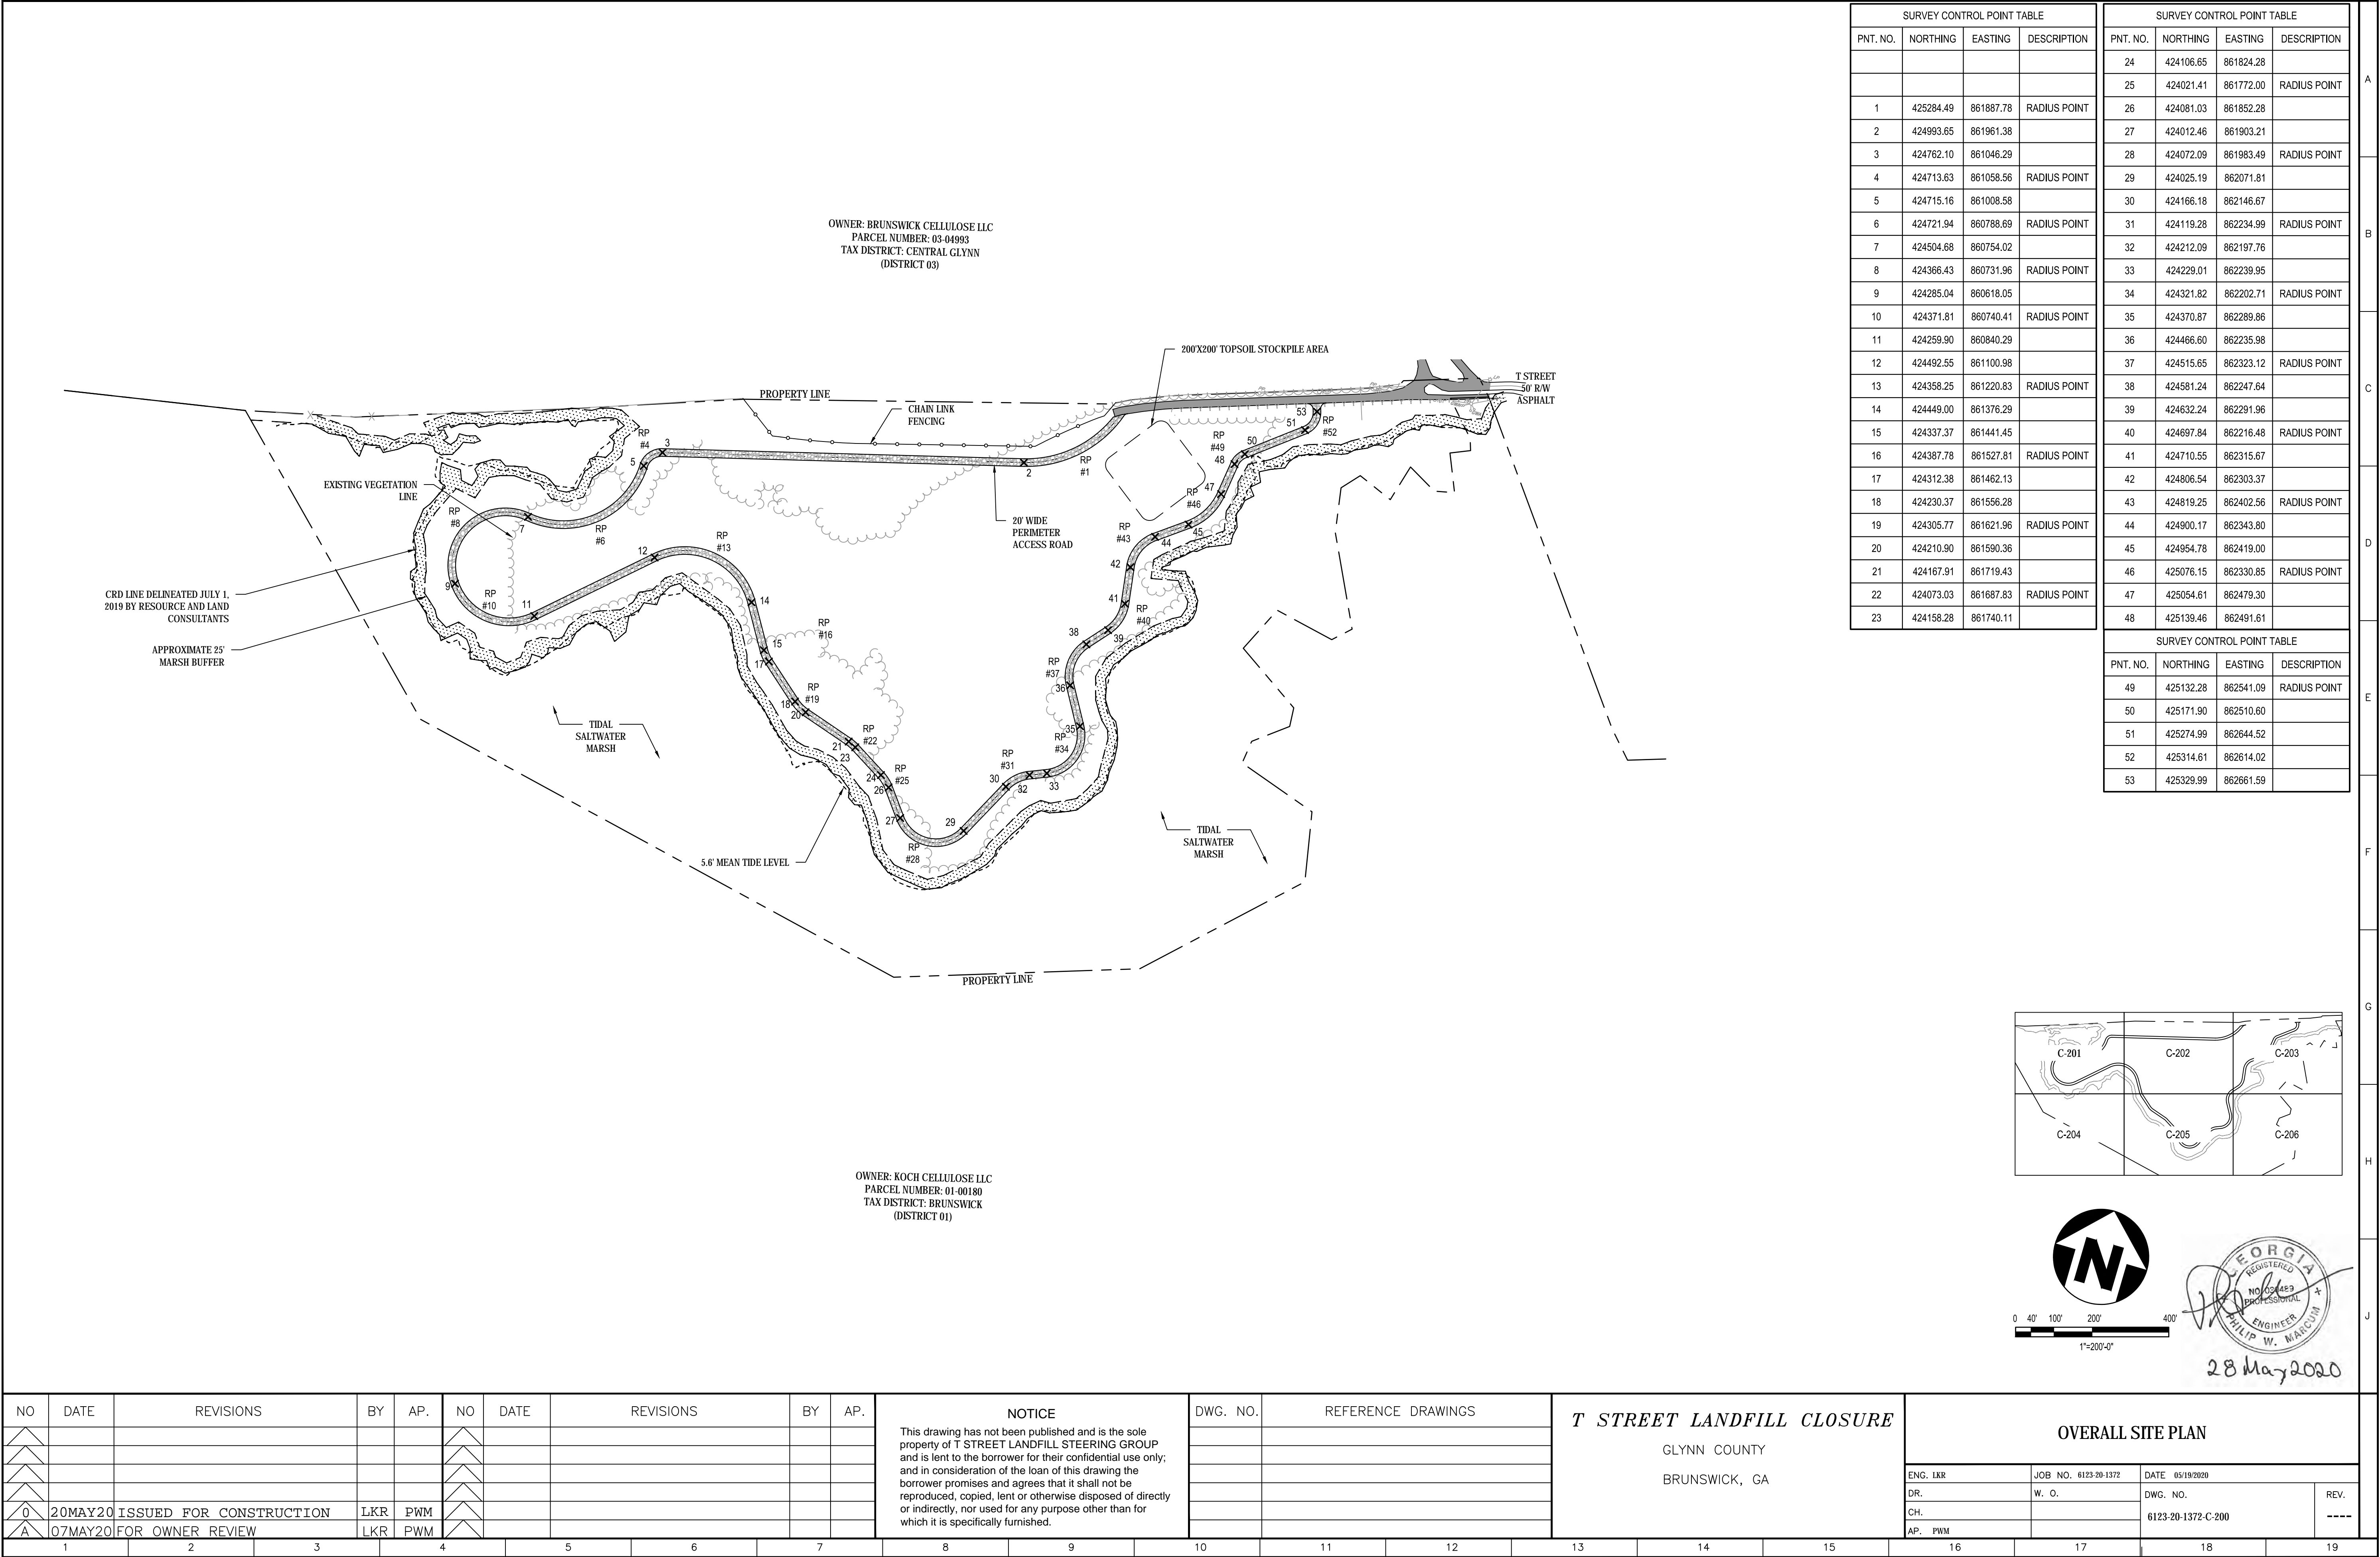
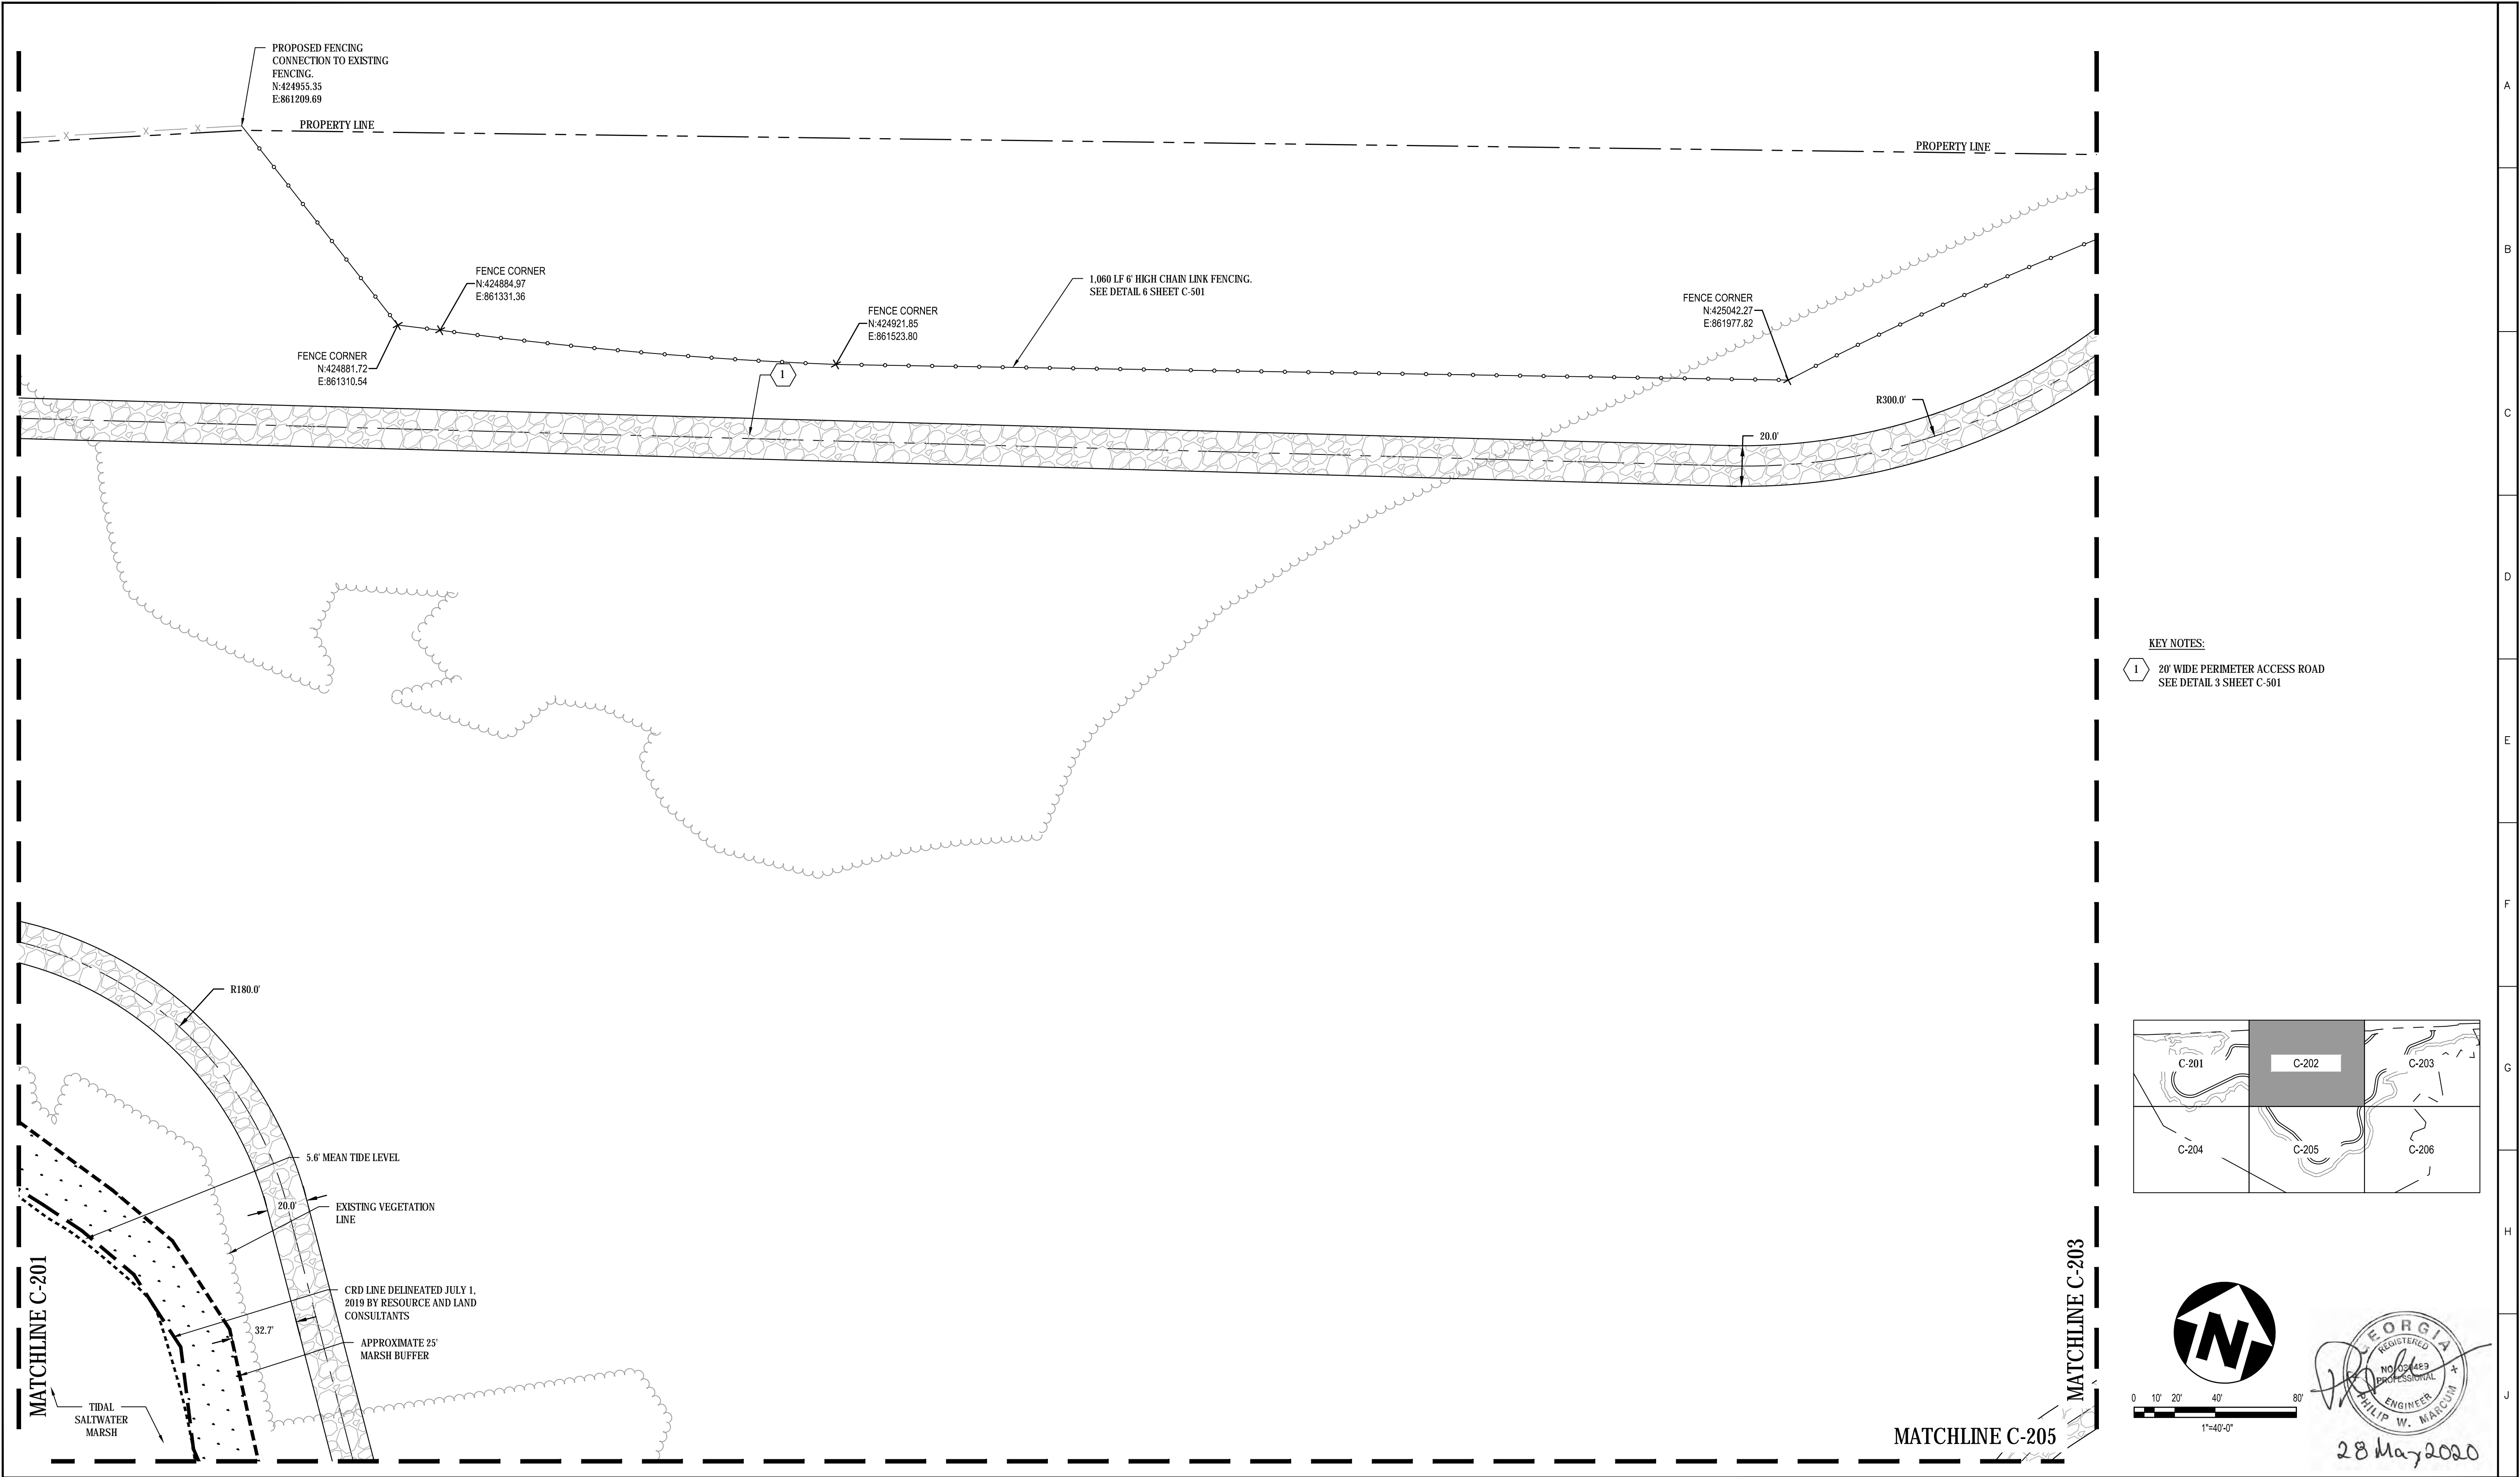
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- GRADING NOTES
1. THE CONTRACTOR SHALL GRADE THE SITE IN ACCORDANCE WITH THE PLANS, SPECIFICATIONS AND GEOTECHNICAL REPORT PREPARED FOR THIS PROJECT.
 2. IF THE GRAVEL ROAD IS NOT CONSTRUCTION IMMEDIATELY AFTER THE INITIAL SUBGRADE PREPARATION, THE CONTRACTOR SHALL BE REQUIRED TO RESTORE THE SUBGRADE PRIOR TO THE PLACEMENT OF THE ROAD.
 3. ALL SPOT ELEVATIONS AND FINISH GRADES ARE TO THE TOP OF THE LANDFILL CAP AND TOP OF GRAVEL ROAD.
 4. DEBRIS OUTSIDE OF THE GRADING LIMITS AND INSIDE OF THE 25' MARSH BUFFER ARE TO BE REMOVED.
 5. THE AREA BETWEEN THE GRADING LIMITS AND THE 25' MARSH BUFFER IS TO BE GRADED TO DRAIN AS NECESSARY AFTER REMOVAL OF DEBRIS.


- LEGEND
- 248— EXISTING MINOR CONTOUR
 - 250--- EXISTING MAJOR CONTOUR
 - 248— PROPOSED MINOR CONTOUR
 - 250--- PROPOSED MAJOR CONTOUR

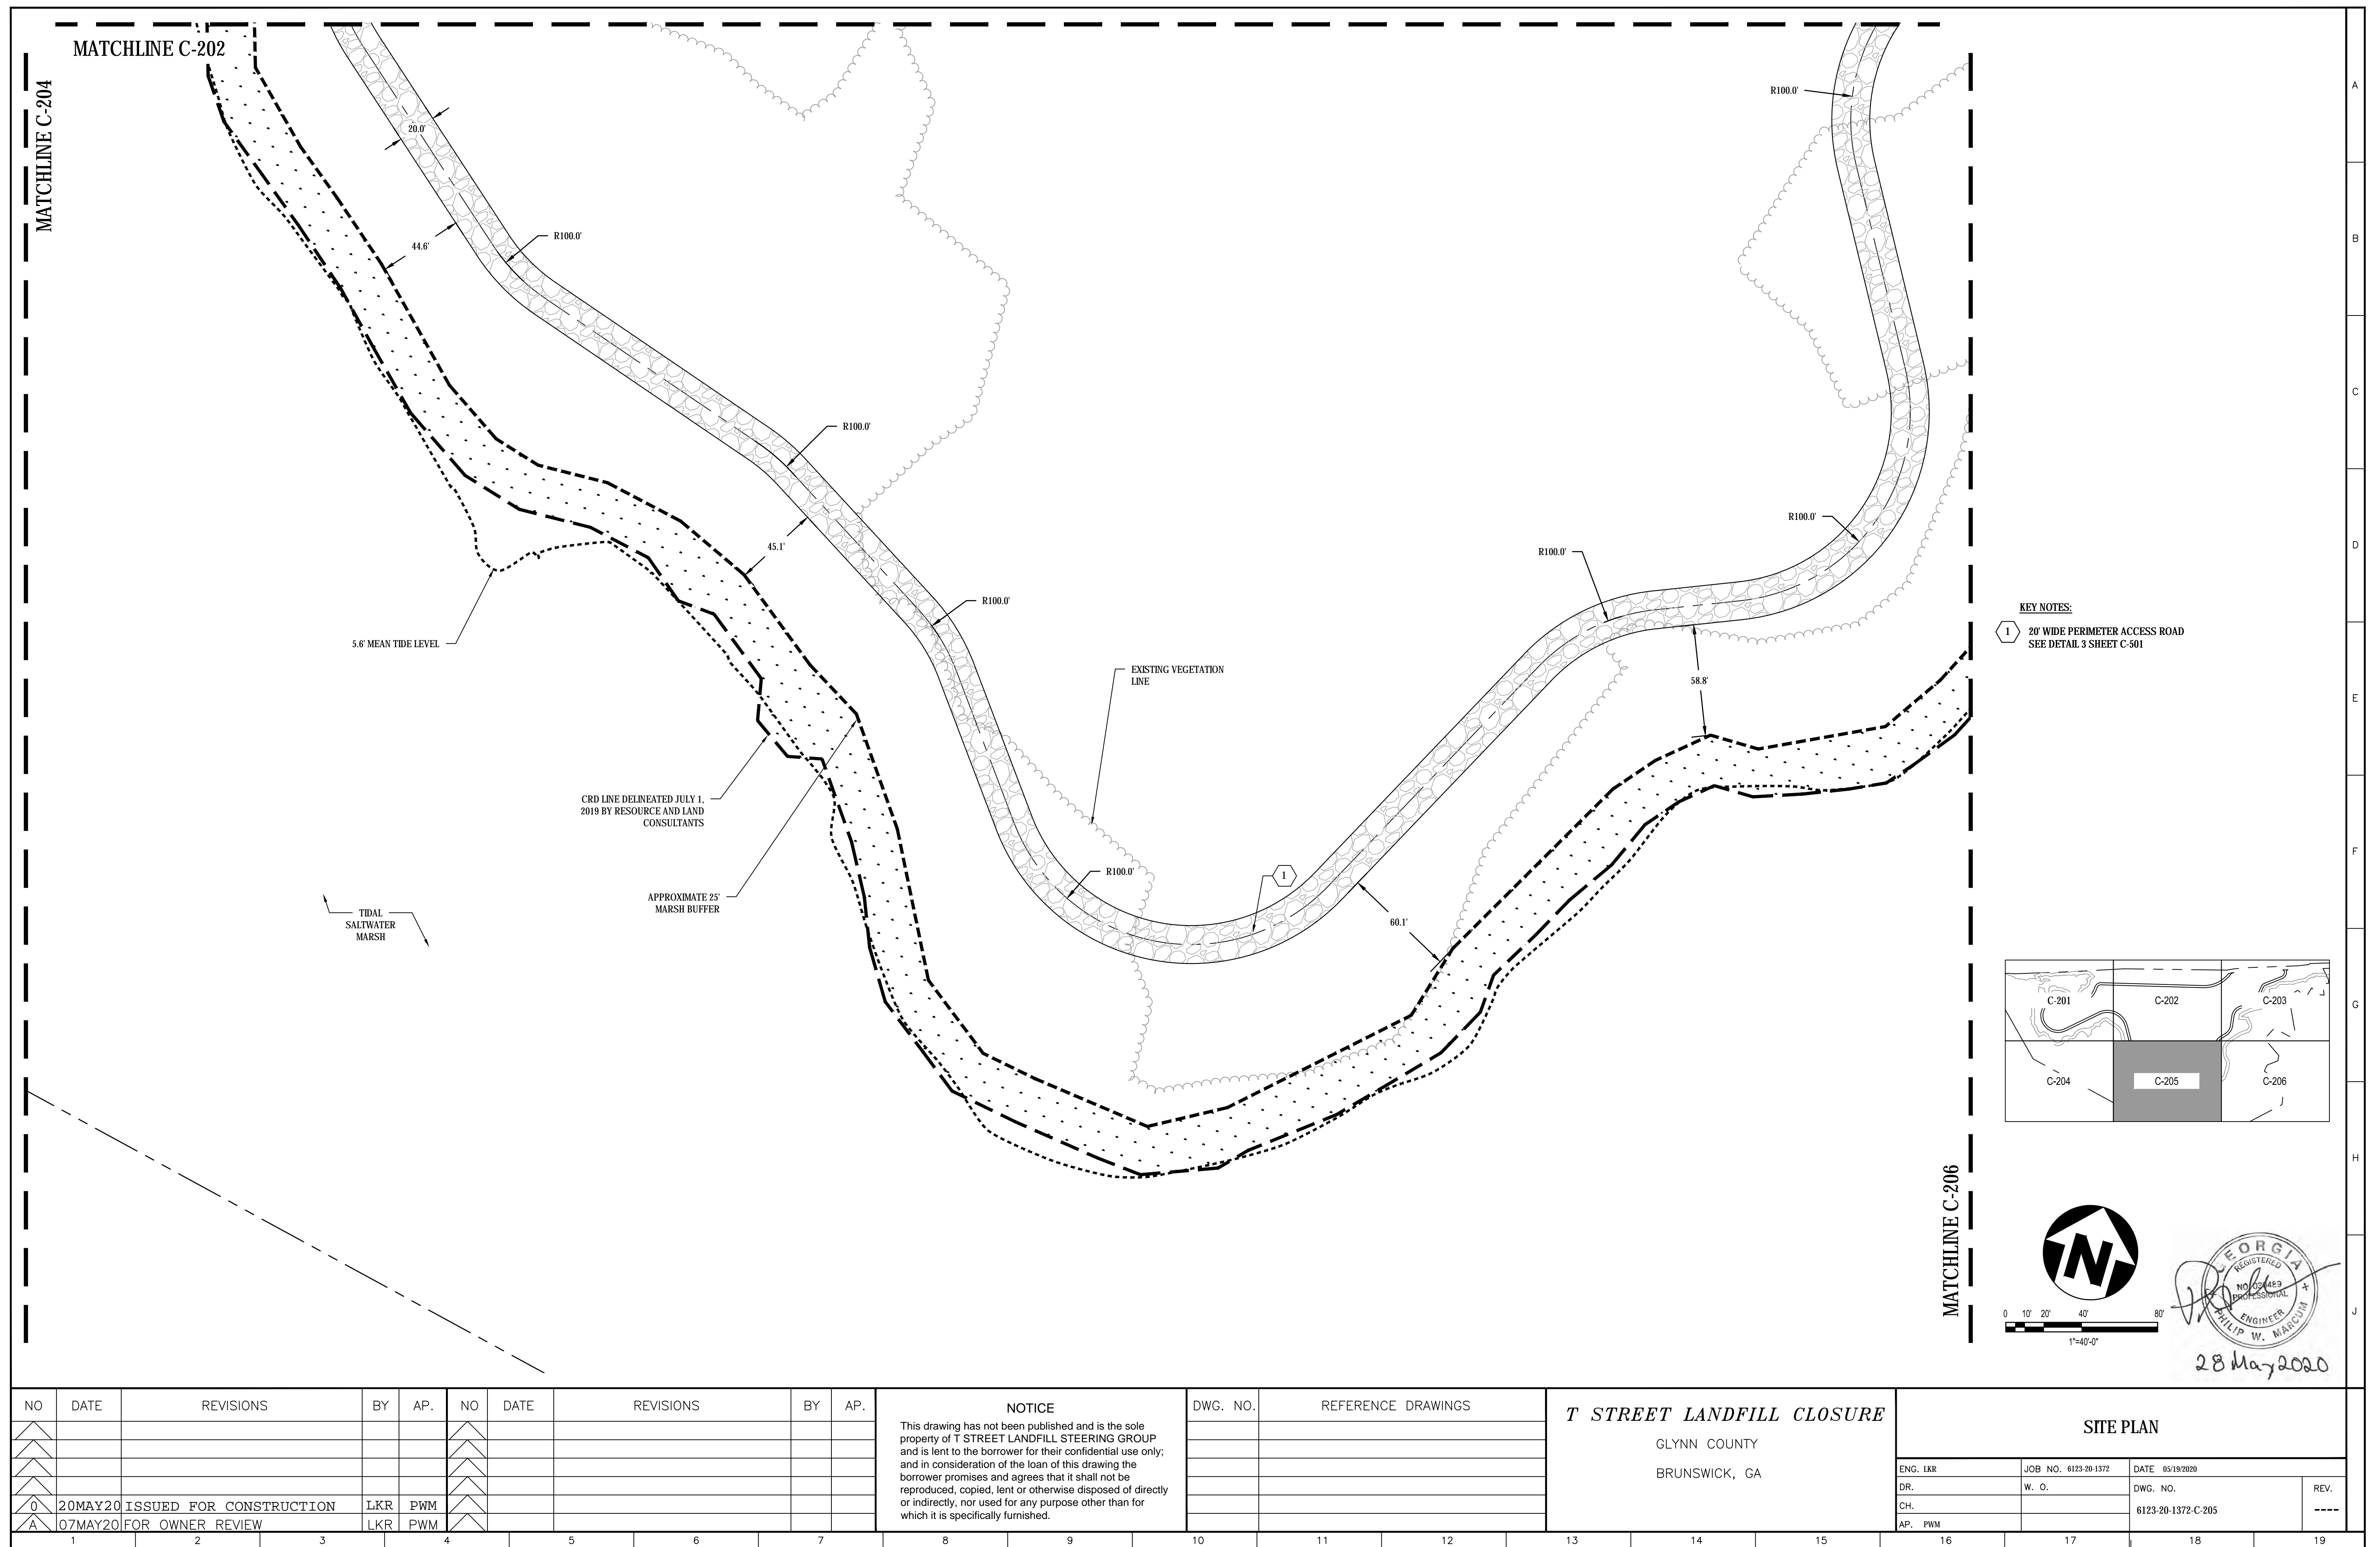

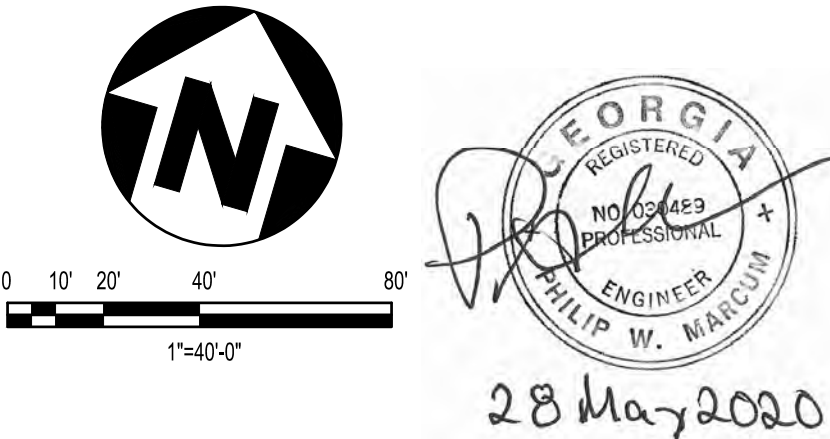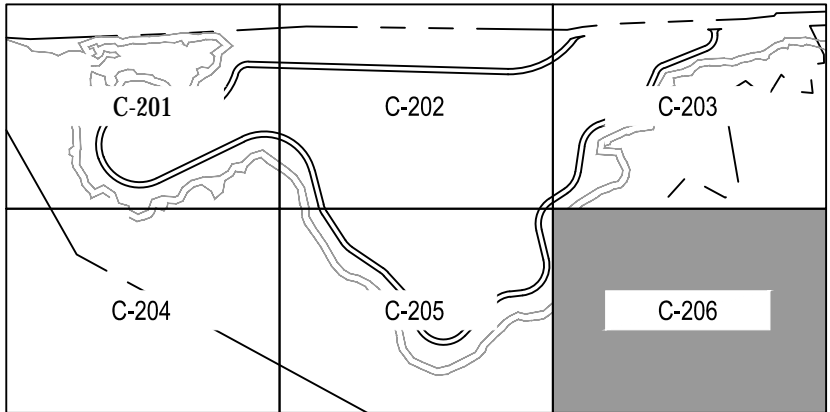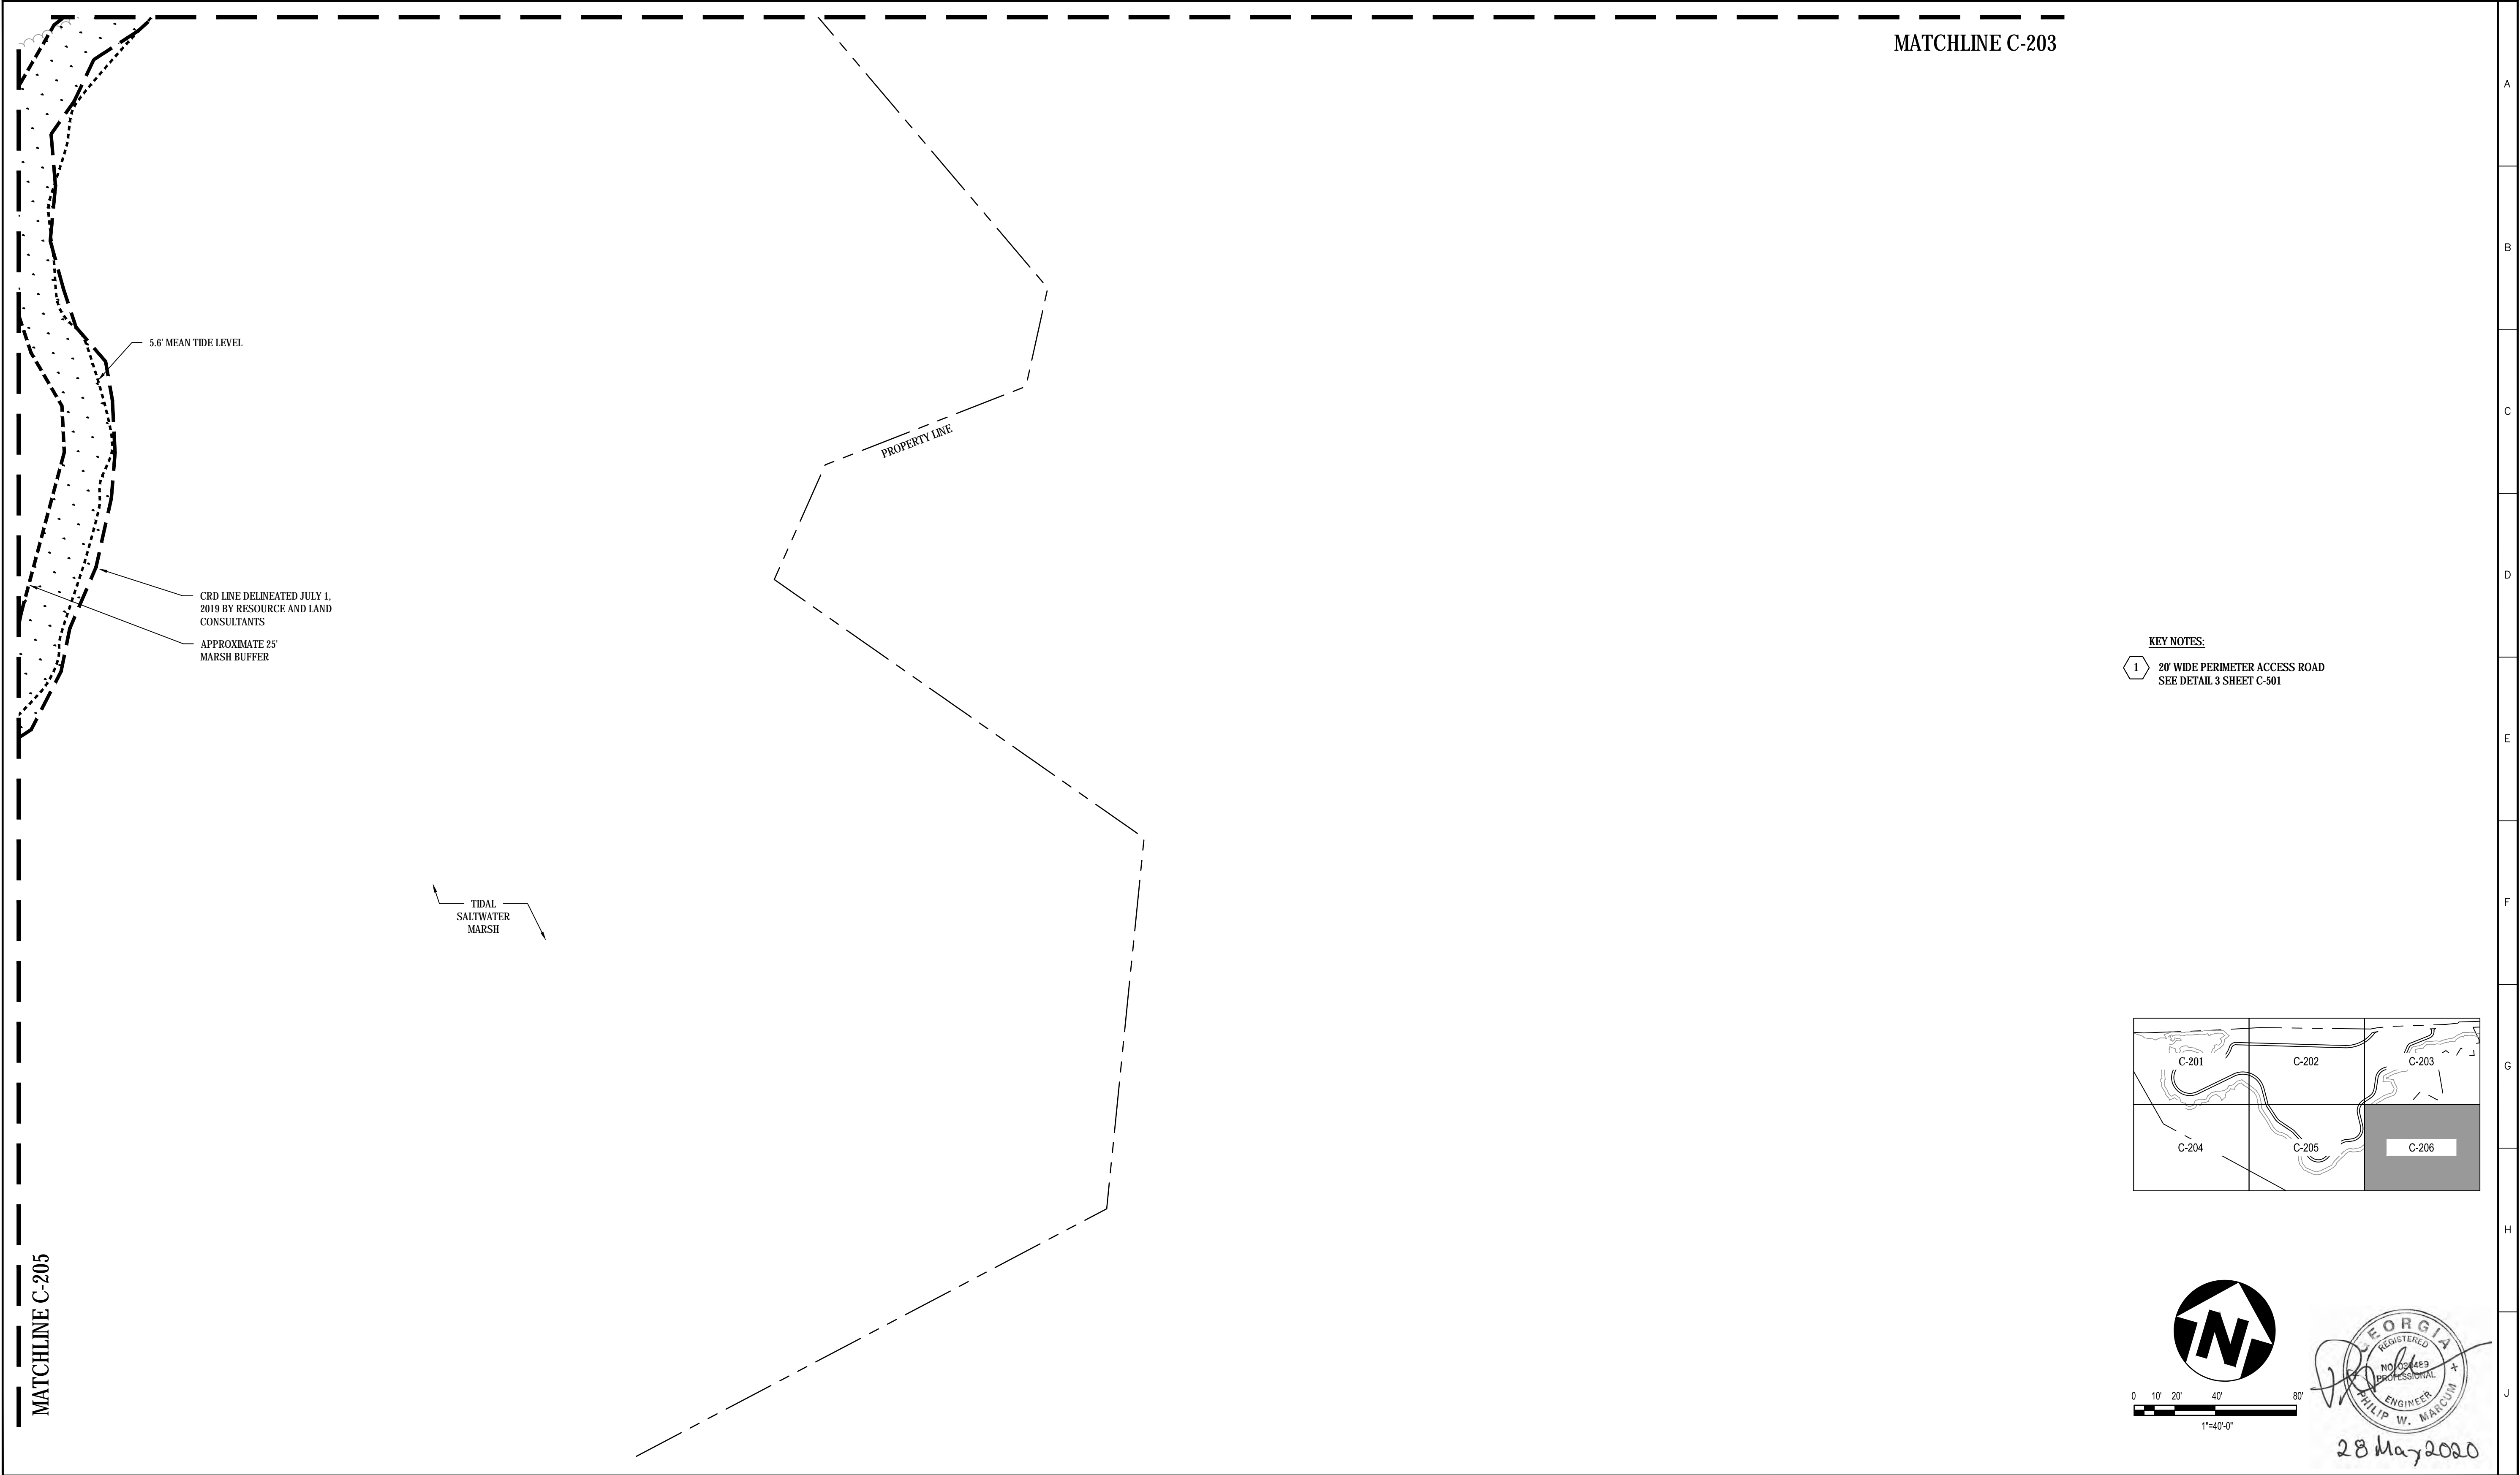OWNER: BRUNSWICK CELLULOSE LLC
PARCEL NUMBER: 03-04993
TAX DISTRICT: CENTRAL GLYNN
(DISTRICT 03)



OWNER: KOCH CELLULOSE LLC
PARCEL NUMBER: 01-00180
TAX DISTRICT: BRUNSWICK
(DISTRICT 01)

NO		DATE		REVISIONS		BY	AP.	NO	DATE	REVISIONS		BY	AP.	NOTICE This drawing has not been published and is the sole property of T STREET LANDFILL STEERING GROUP and is lent to the borrower for their confidential use only; and in consideration of the loan of this drawing the borrower promises and agrees that it shall not be reproduced, copied, lent or otherwise disposed of directly or indirectly, nor used for any purpose other than for which it is specifically furnished.	DWG. NO.	REFERENCE DRAWINGS			<i>T STREET LANDFILL CLOSURE</i> GLYNN COUNTY BRUNSWICK, GA			OVERALL GRADING PLAN																
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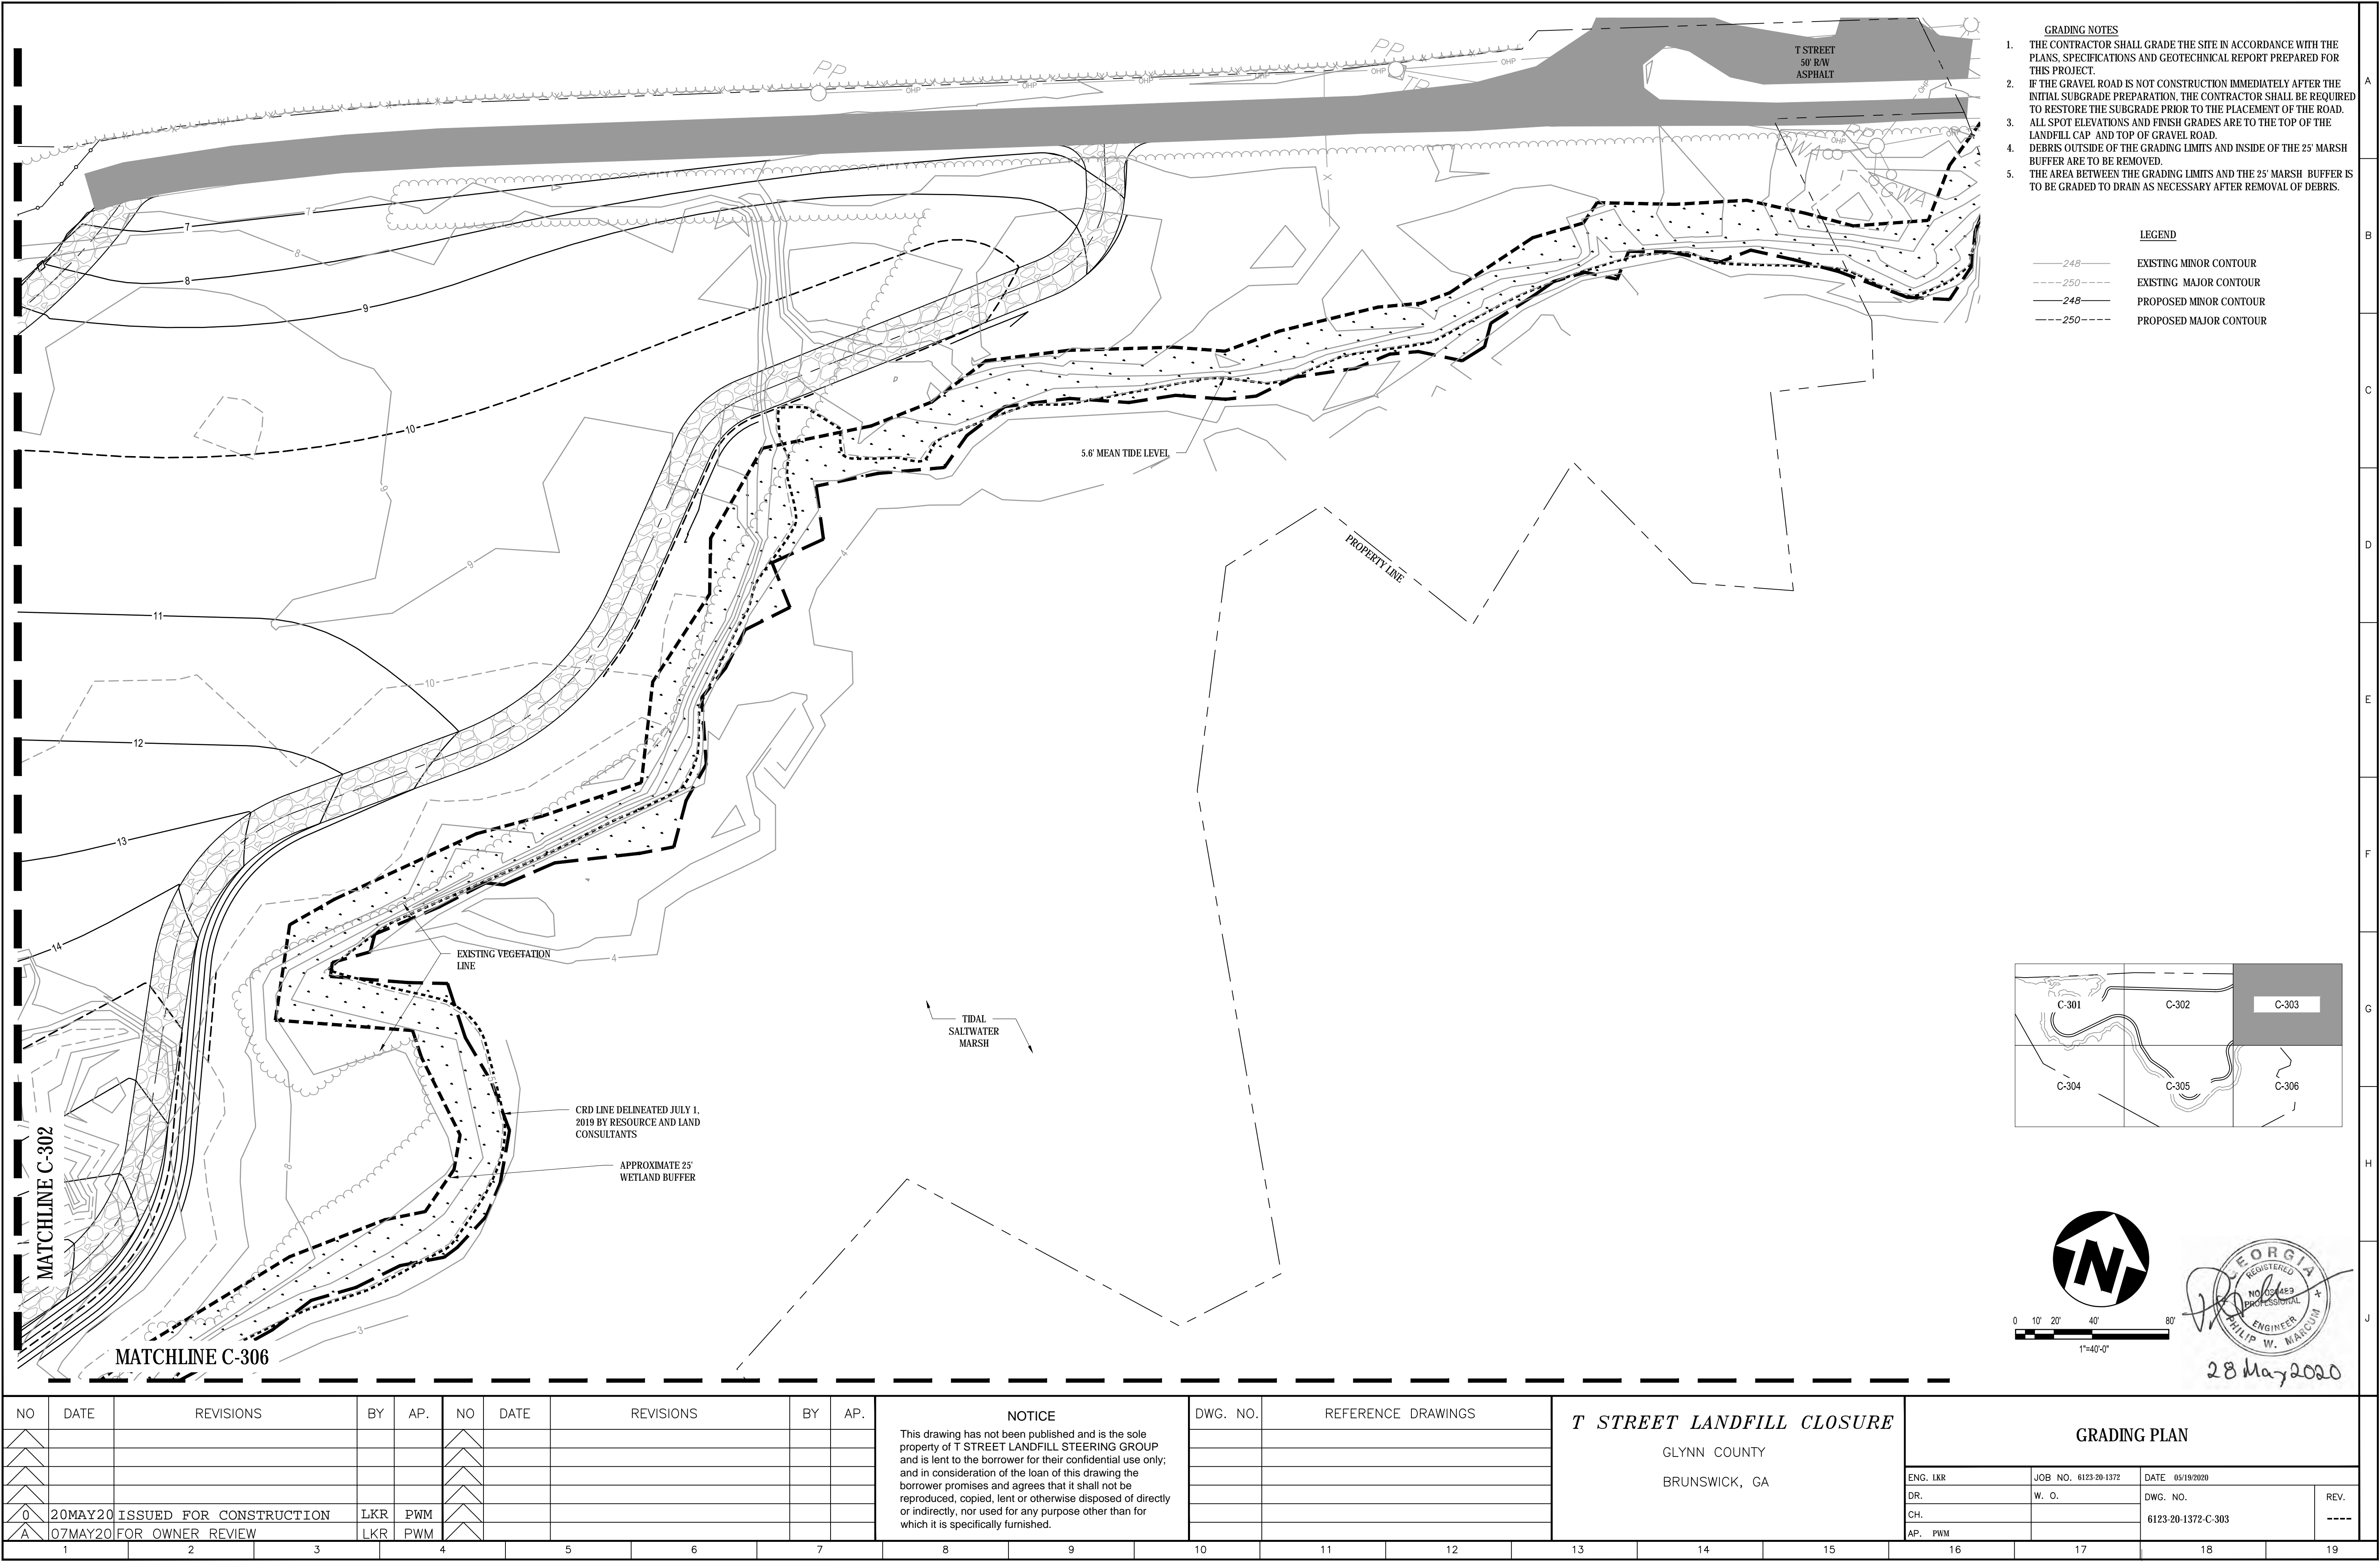


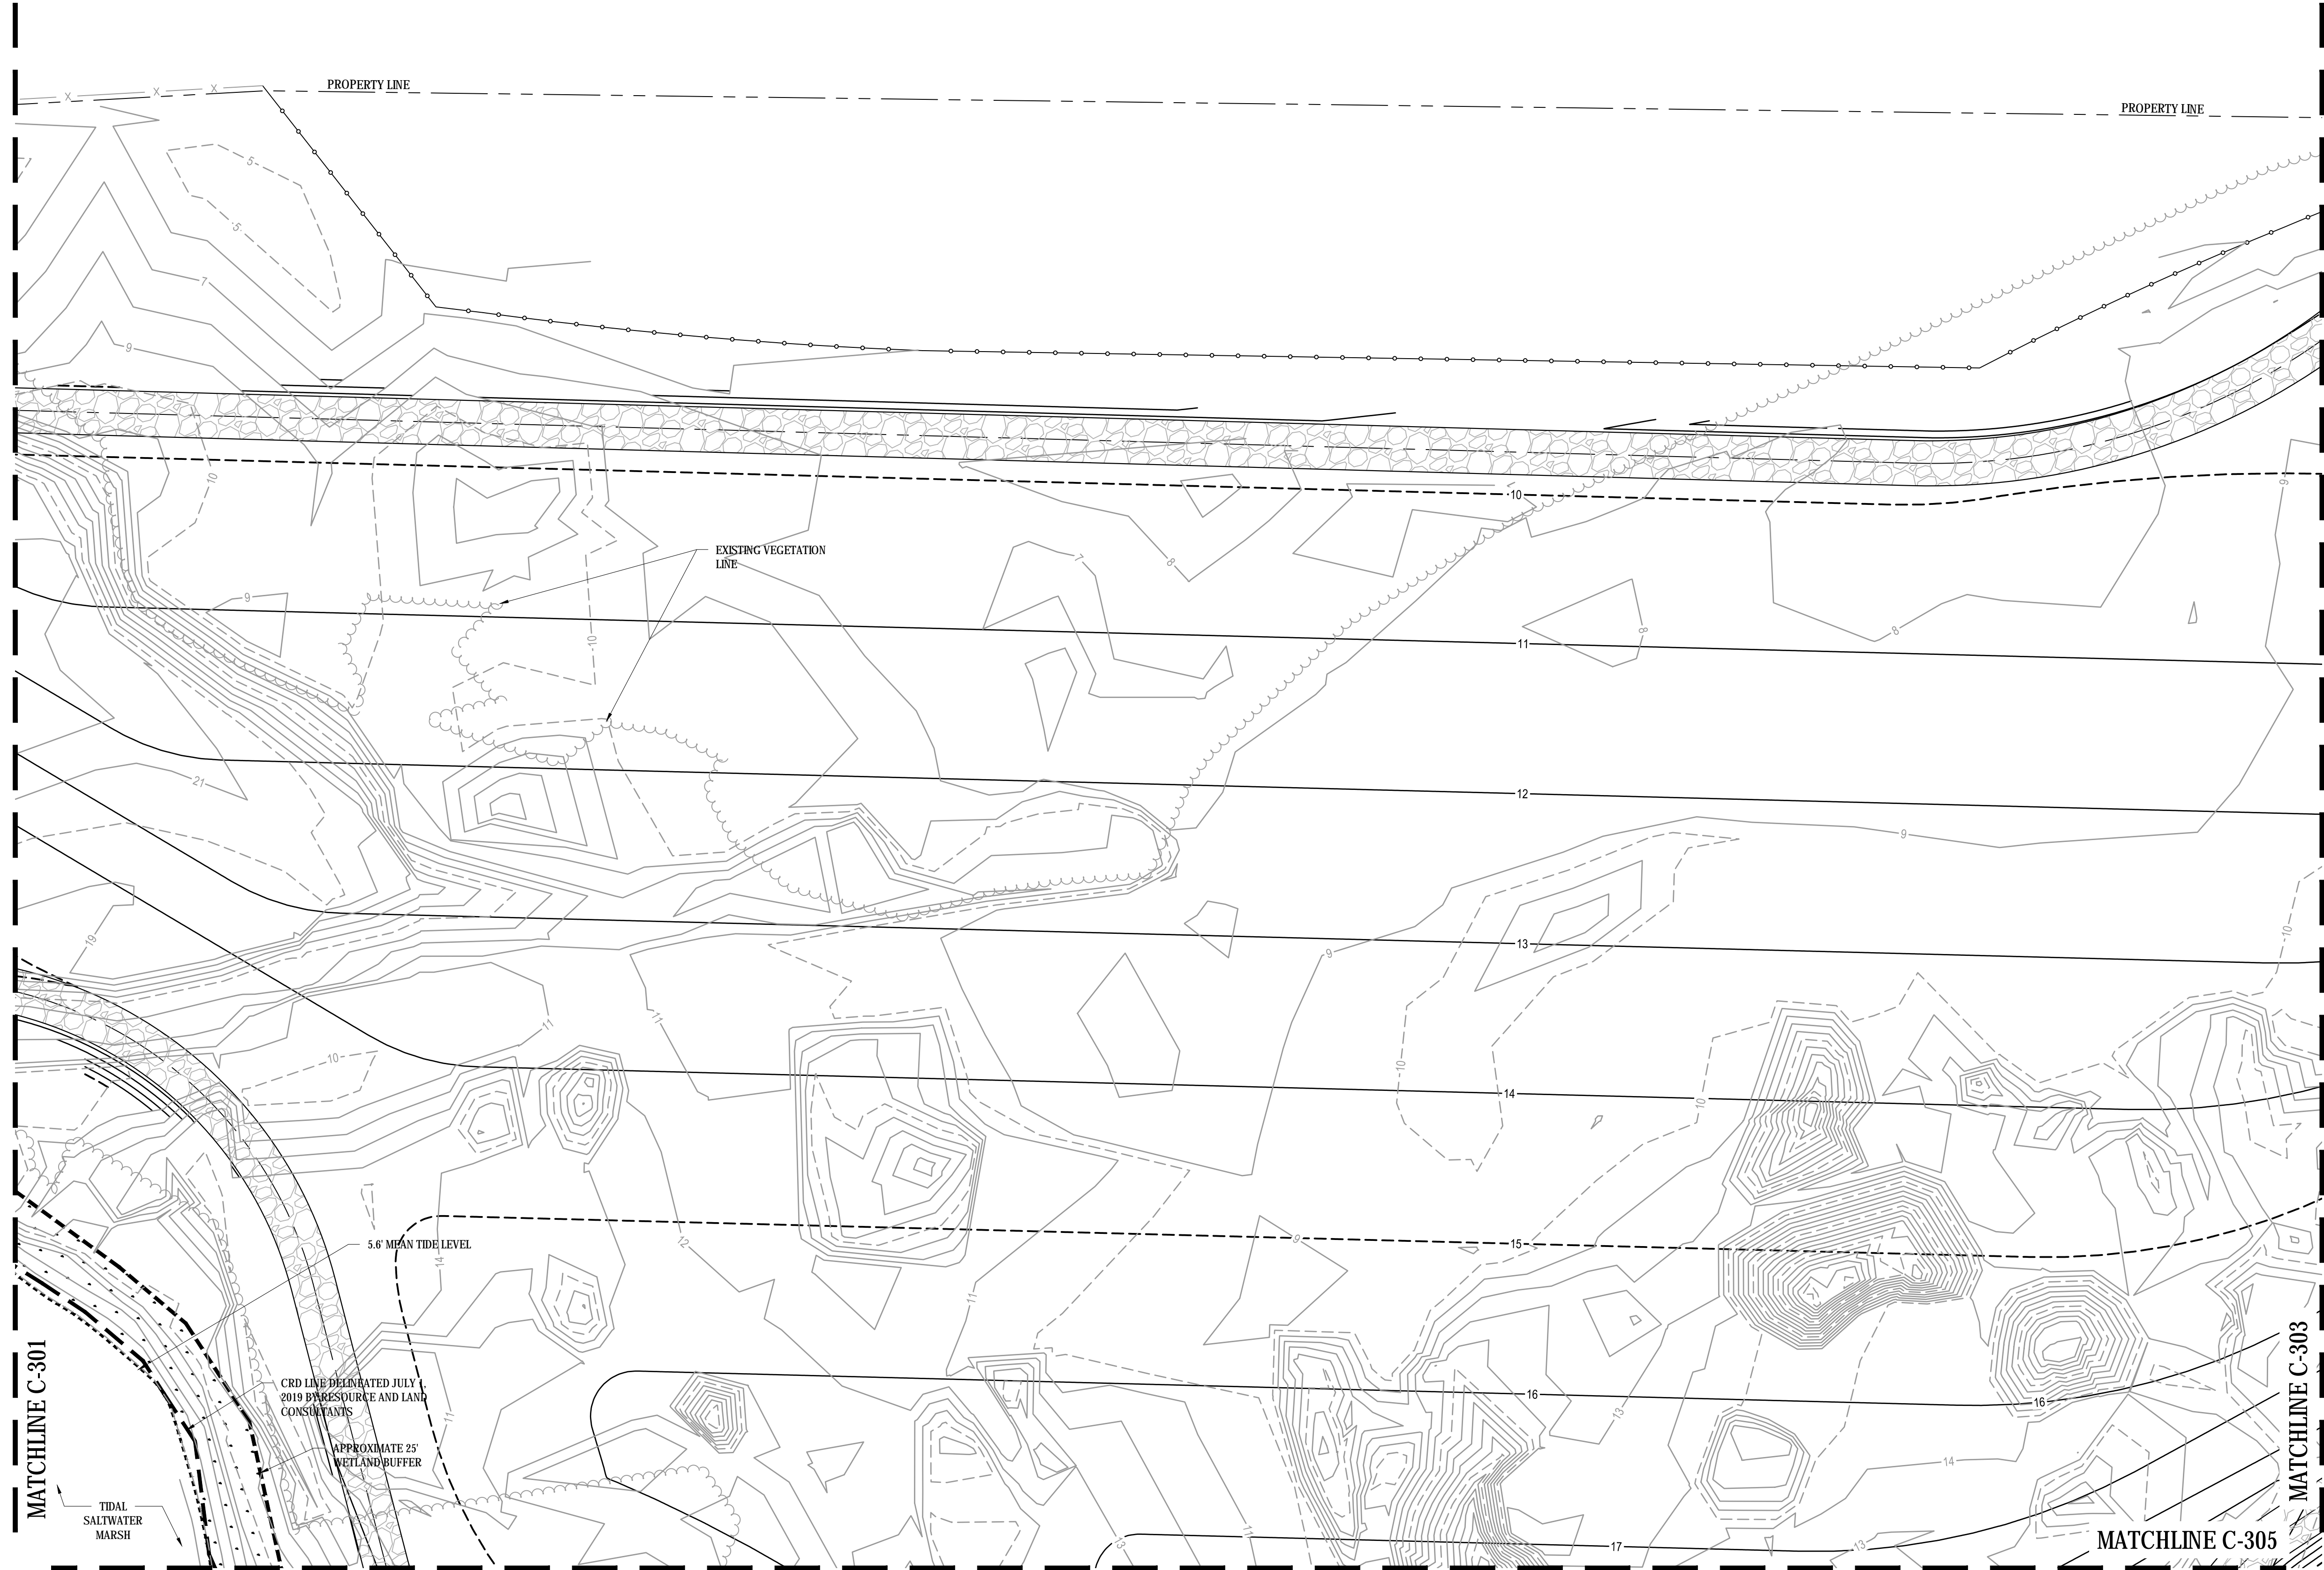
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 4. DEBRIS OUTSIDE OF THE GRADING LIMITS AND INSIDE OF THE 25' MARSH BUFFER ARE TO BE REMOVED.
 5. THE AREA BETWEEN THE GRADING LIMITS AND THE 25' MARSH BUFFER IS TO BE GRADED TO DRAIN AS NECESSARY AFTER REMOVAL OF DEBRIS.

- LEGEND
- 248— EXISTING MINOR CONTOUR
 - 250--- EXISTING MAJOR CONTOUR
 - 248— PROPOSED MINOR CONTOUR
 - 250--- PROPOSED MAJOR CONTOUR

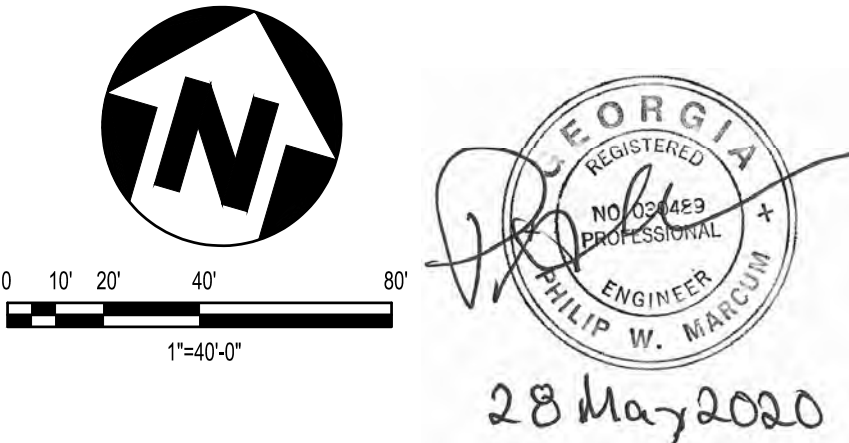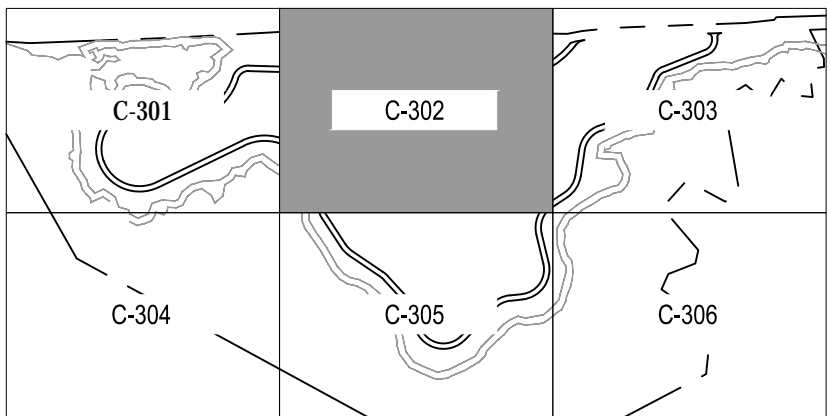

NO		DATE		REVISIONS		BY	AP.	NO	DATE	REVISIONS		BY	AP.	NOTICE		DWG. NO.	REFERENCE DRAWINGS			T STREET LANDFILL CLOSURE			GRADING PLAN														
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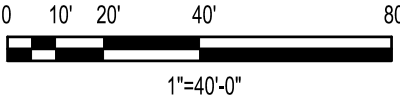
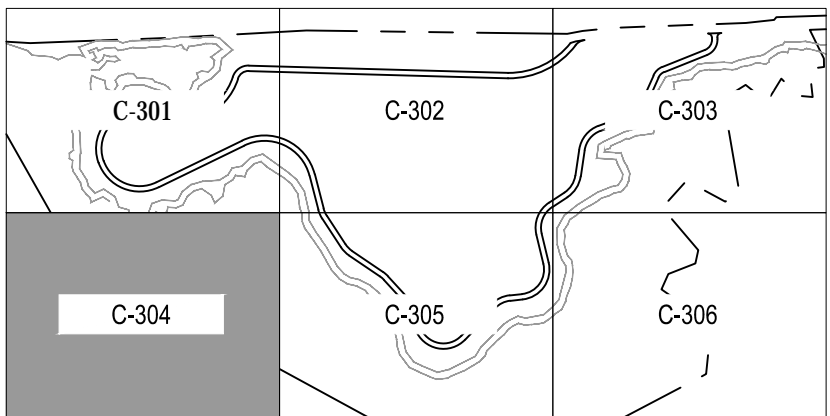
MATCHLINE C-301

MATCHLINE C-305
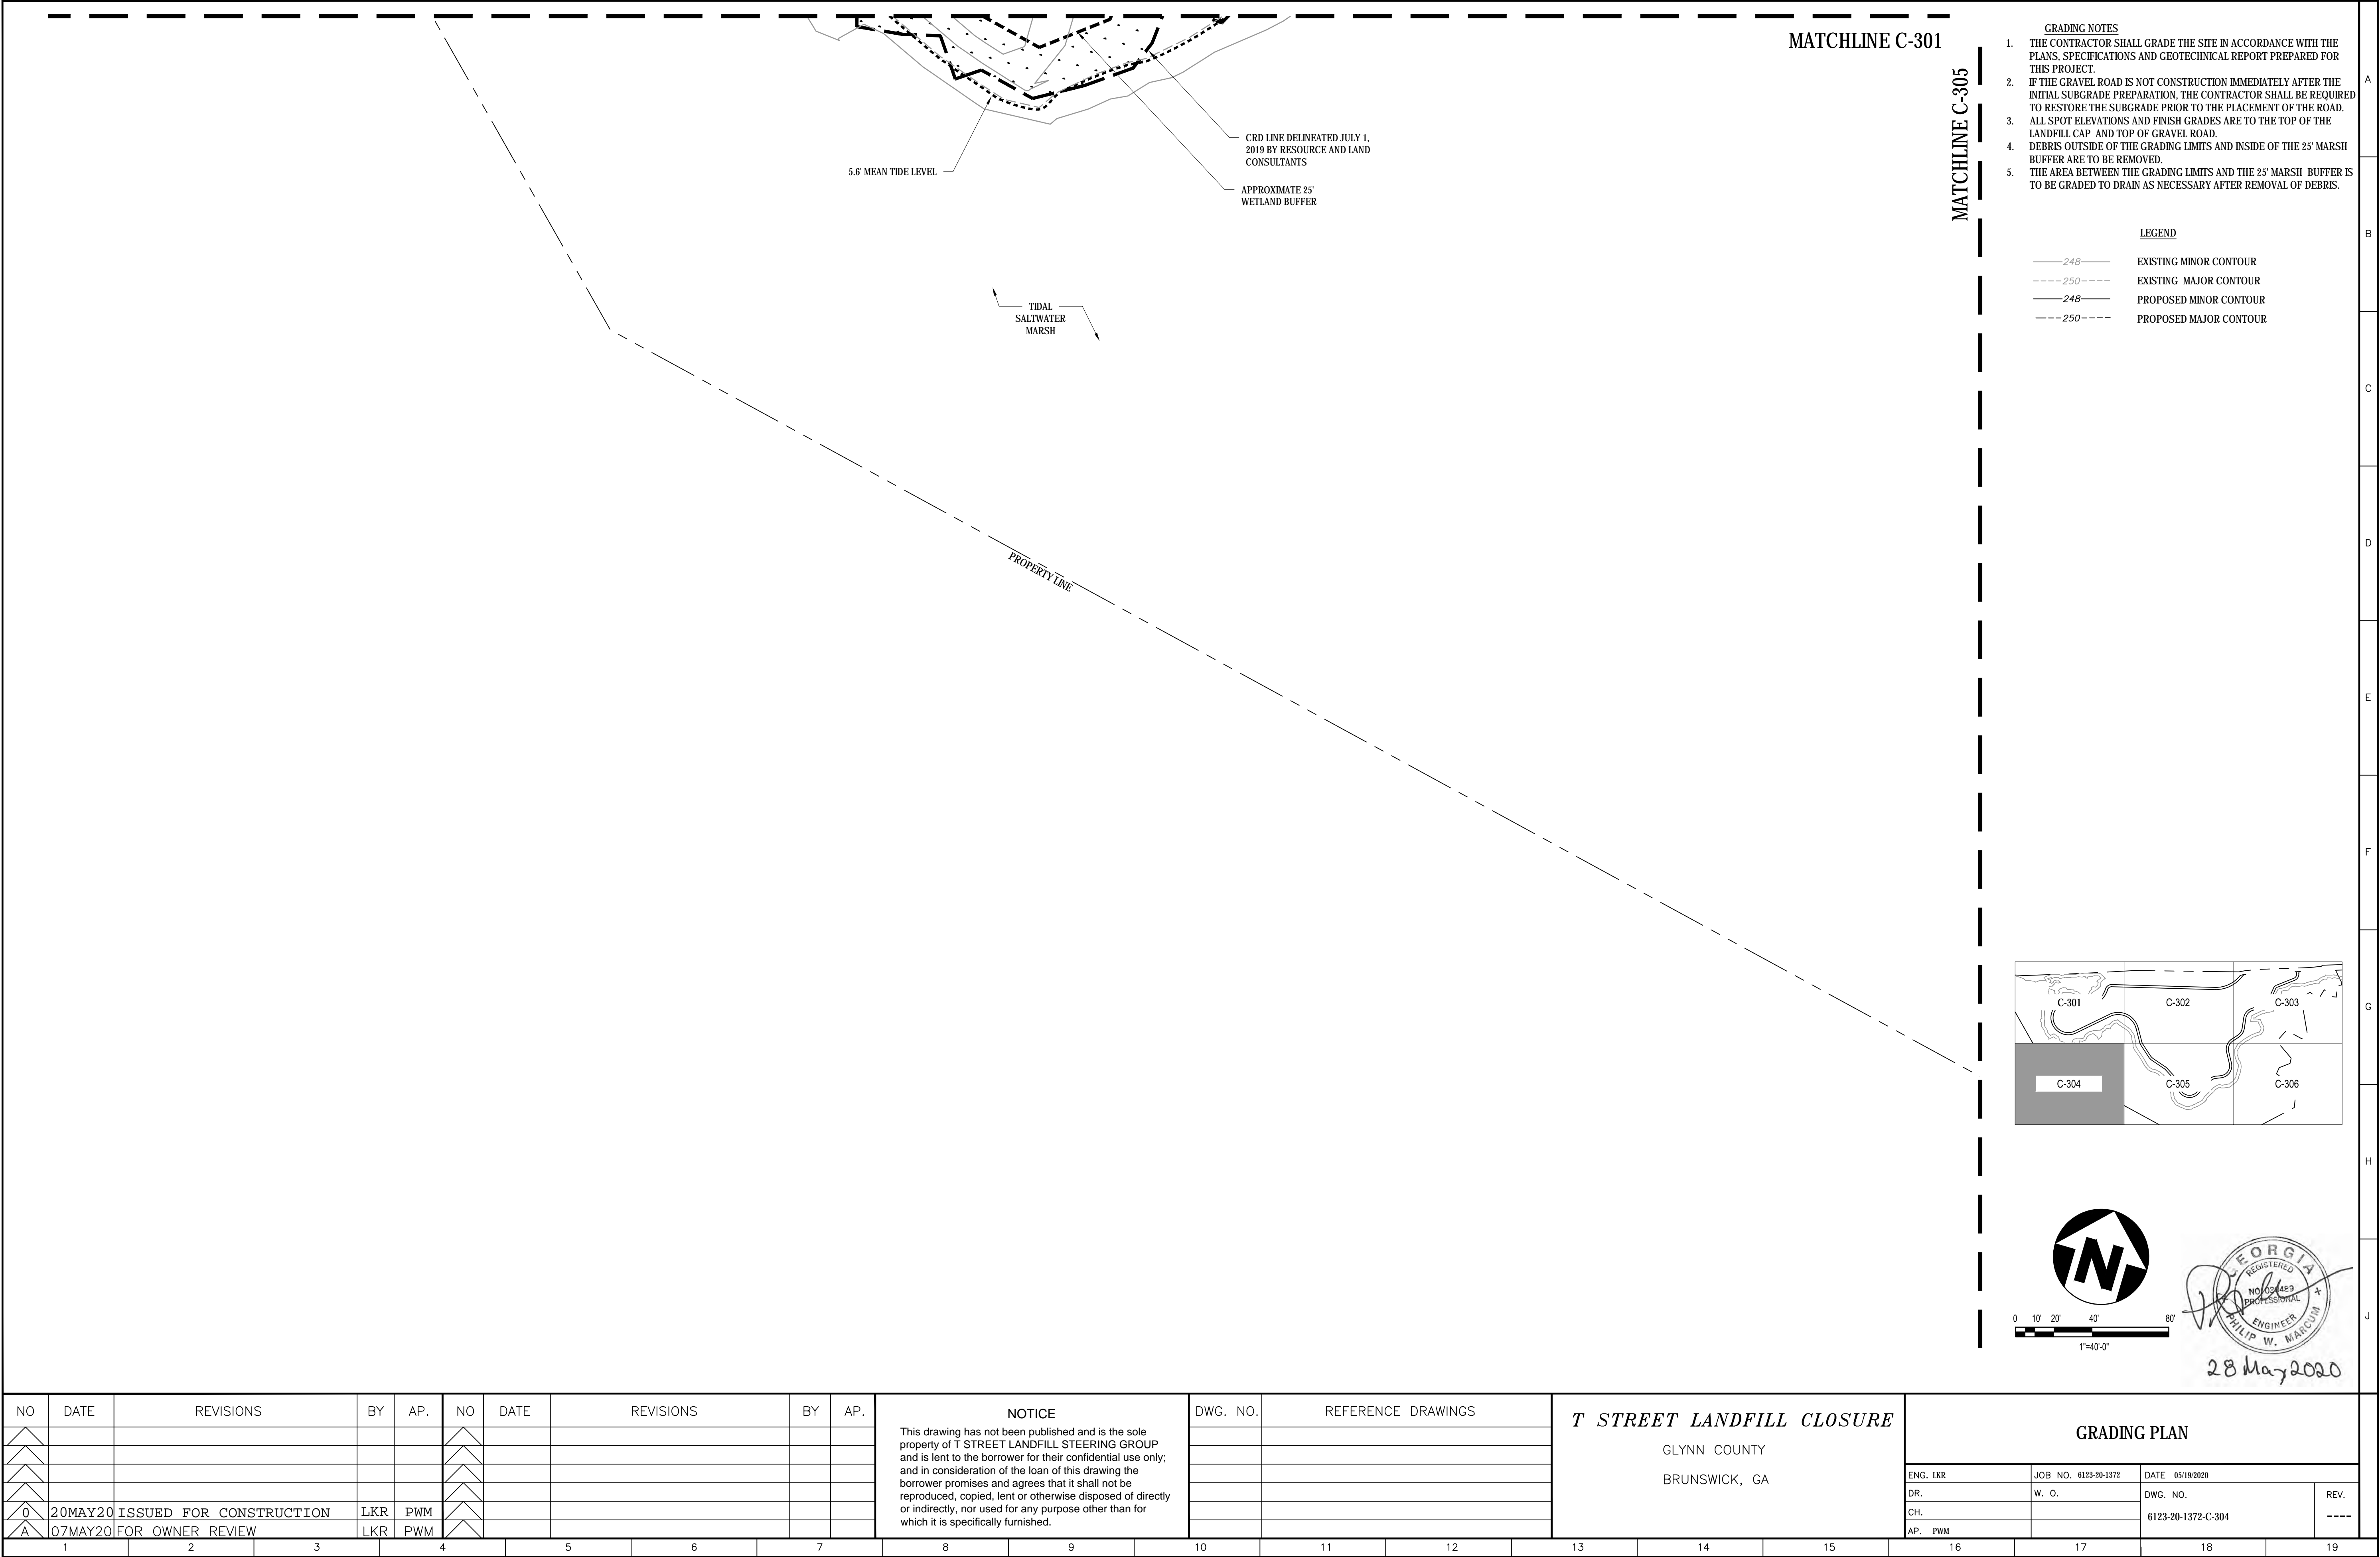
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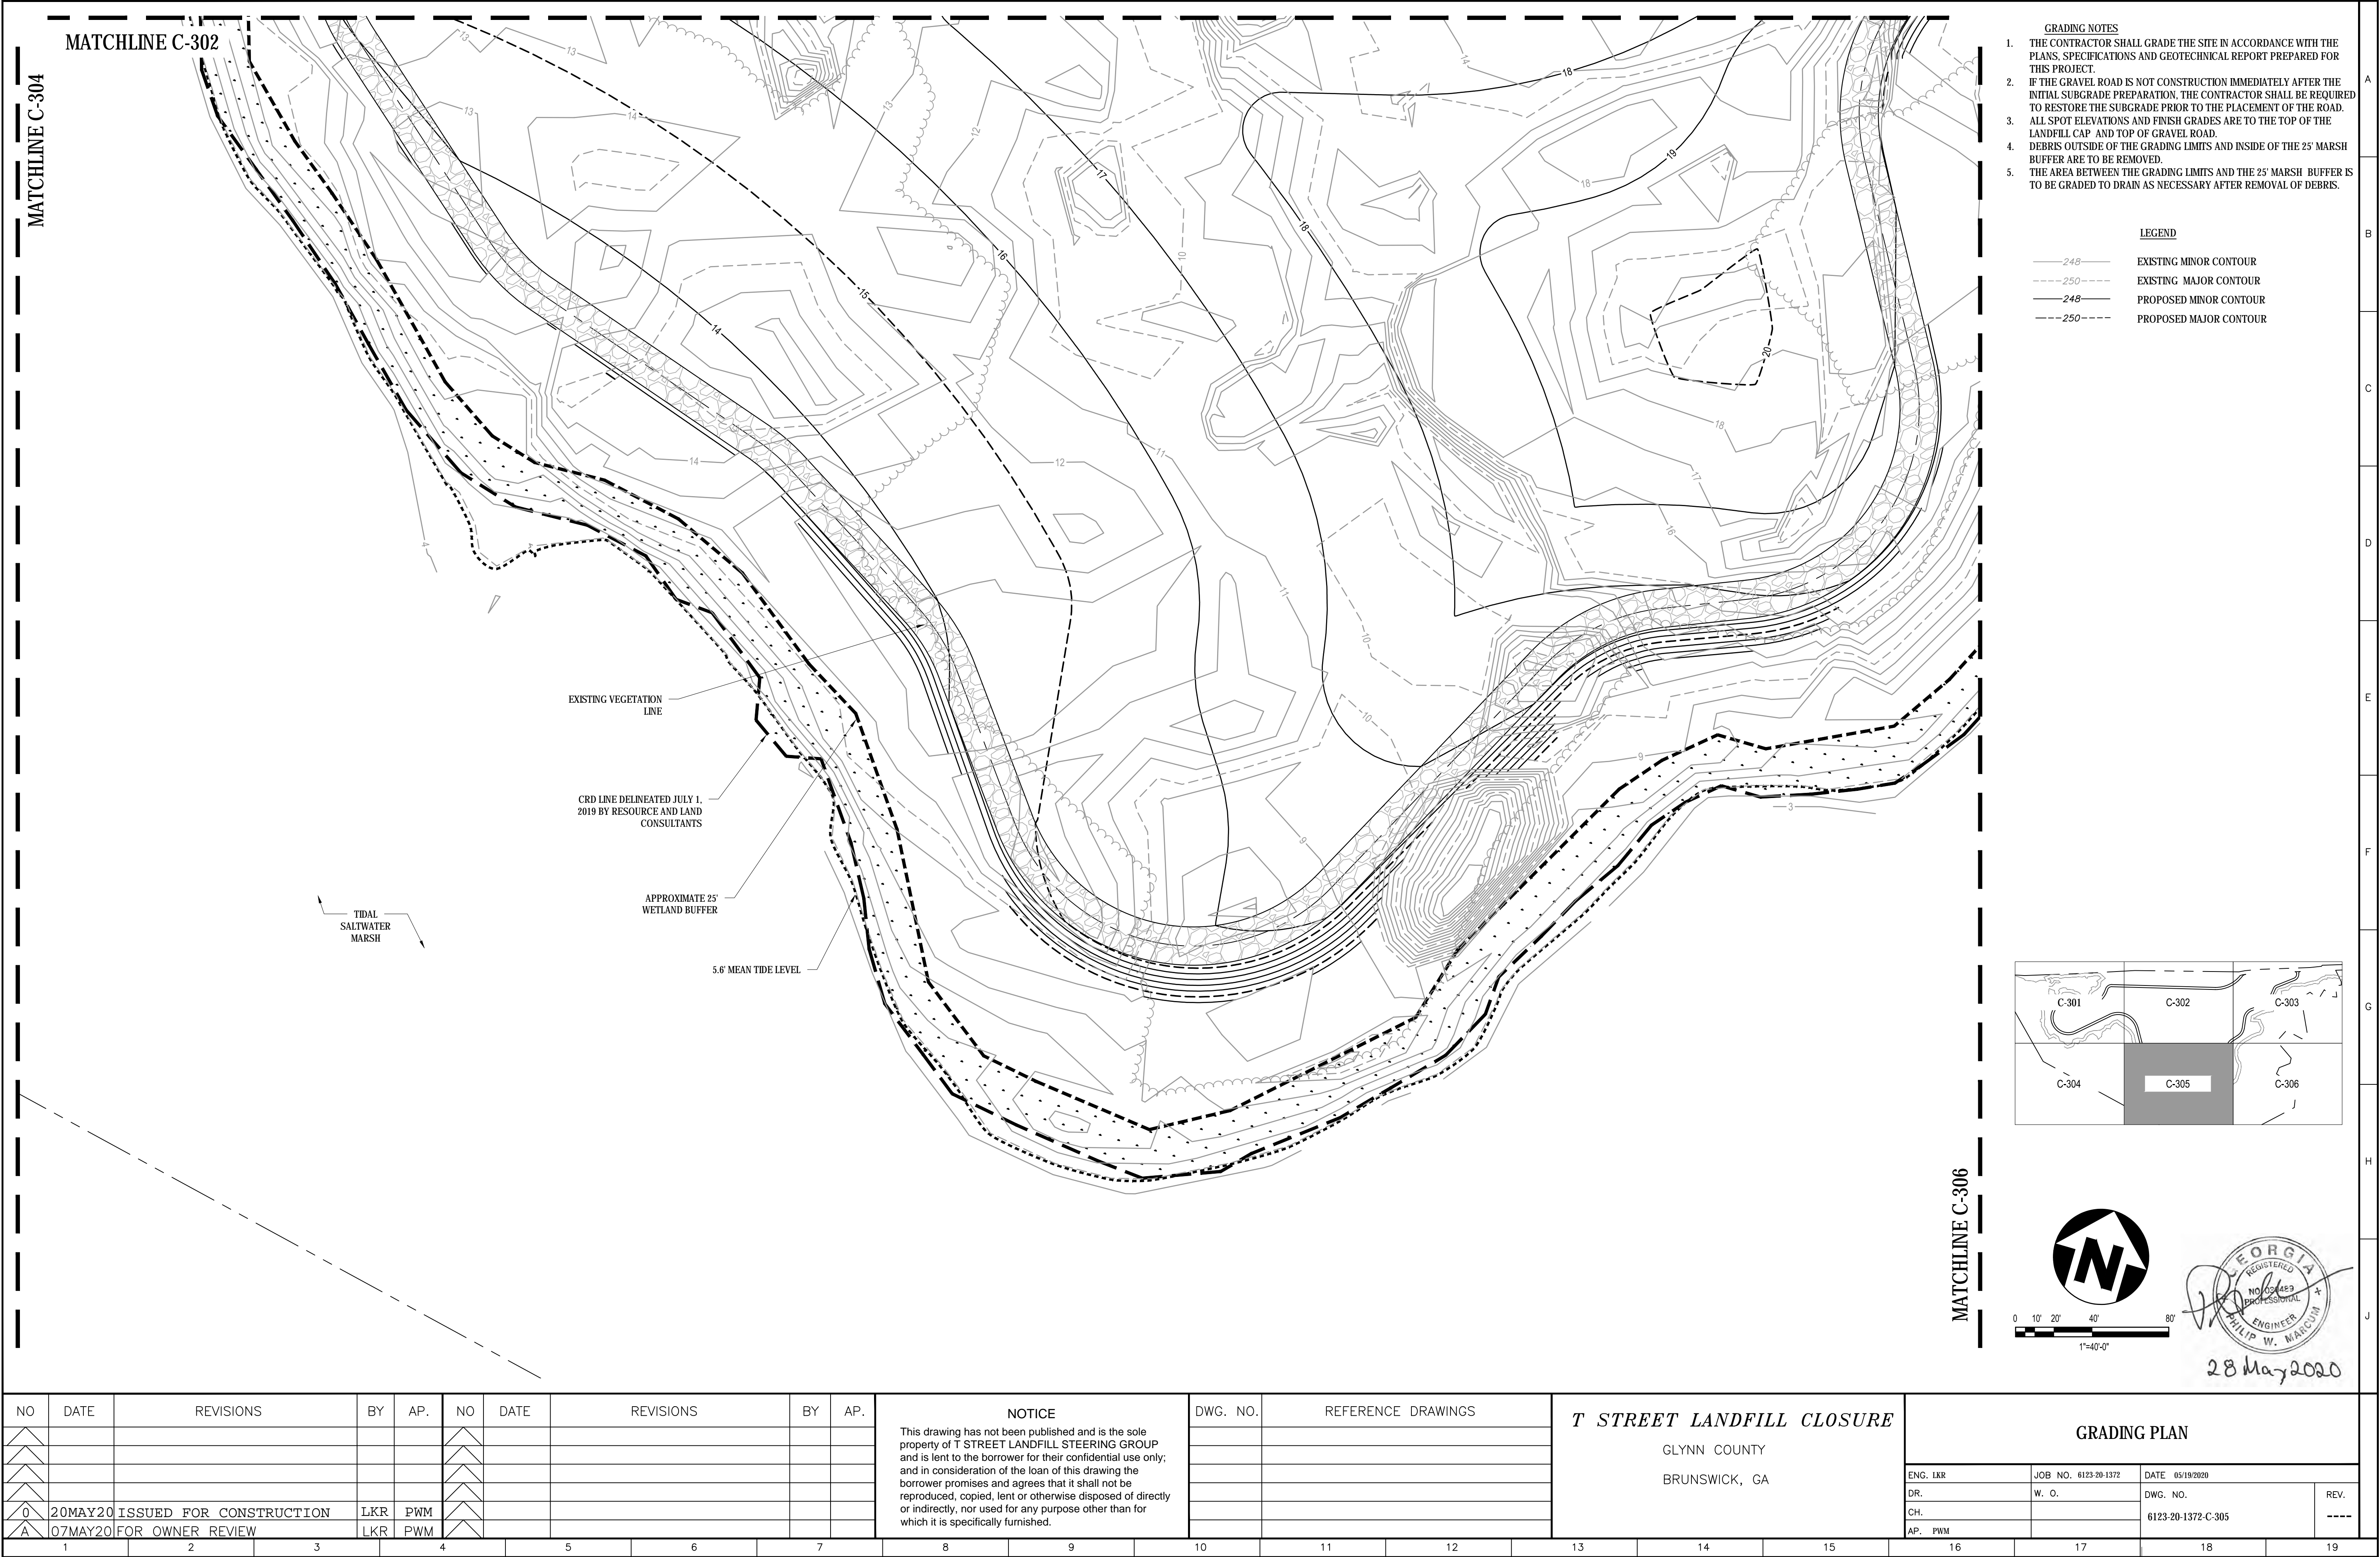
LEGEND


- 248— EXISTING MINOR CONTOUR
---250--- EXISTING MAJOR CONTOUR
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28 May 2020

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PARCEL NUMBER: 03-04993
TAX DISTRICT: CENTRAL GLYNN
(DISTRICT 03)

OWNER: KOCH CELLULOSE LLC
PARCEL NUMBER: 01-00180
TAX DISTRICT: BRUNSWICK
(DISTRICT 01)

CRD LINE DELINEATED JULY 1, 2019 BY RESOURCE AND LAND CONSULTANTS

APPROXIMATE 25' MARSH BUFFER

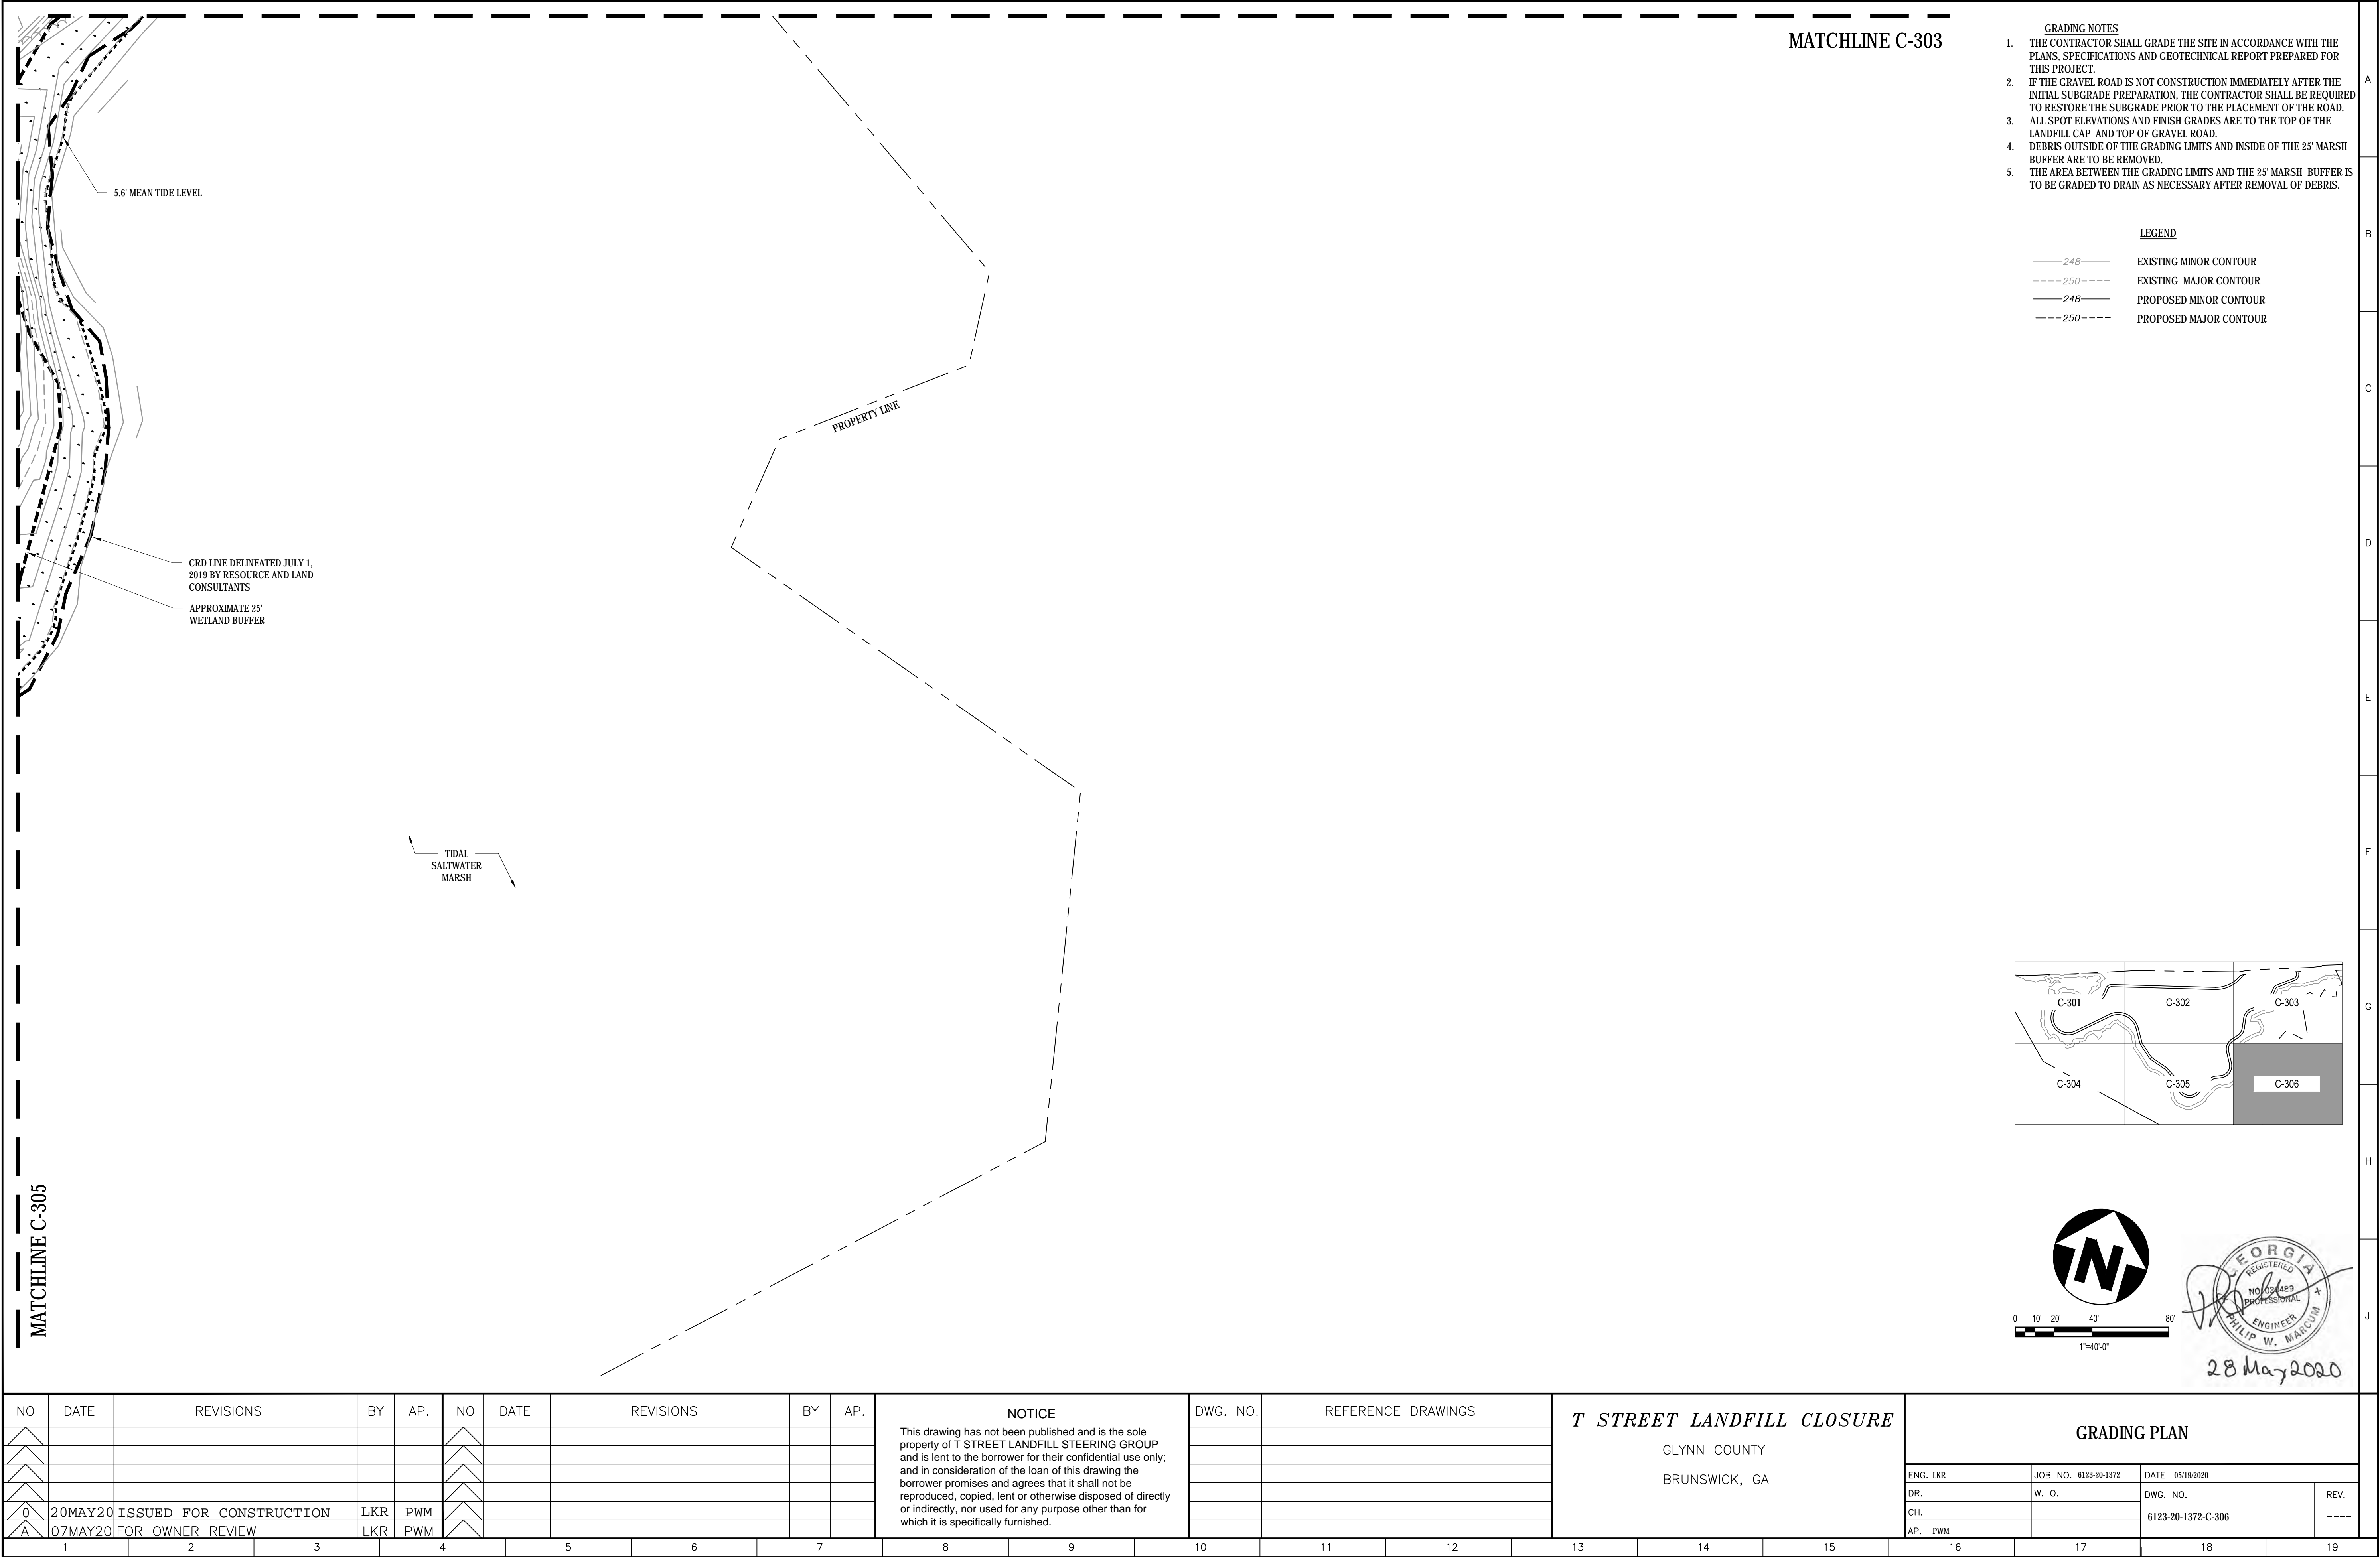EXISTING VEGETATION LINE

SAMPLING LOCATION #2

SAMPLING LOCATION #1

T STREET
50' RW
ASPHALT

PROPERTY LINE

TIDAL SALTWATER MARSH

5.6' MEAN TIDE LEVEL

CONSTRUCTION SEQUENCE

1. INSTALL CONSTRUCTION ENTRANCE.
2. CLEAR AND GRUB FOR SILT FENCE AND INSTALL SILT FENCE
3. PERFORM SITE DEMOLITION ACTIVITIES AS SHOWN ON SHEET 4.
4. COMPLETE CLEARING AND GRUBBING UP TO THE PROPOSED LIMITS OF CONSTRUCTION.
5. PERFORM SITE REGRADING IN ACCORDANCE WITH THE FINISH GRADES.
6. INSTALL FINAL COVER IN ACCORDANCE WITH THE FINISH GRADES.
7. CONSTRUCT PERIMETER ACCESS ROAD PER SITE PLAN.
8. APPLY SEED AND MULCH TO ESTABLISH PERMANENT STABILIZATION OVER FINAL COVER AND DISTURBED AREA.
9. INSTALL RIP RAP ALONG THE TOE OF SLOPE OF THE LANDFILL.
10. REMOVE SEDIMENT CONTROLS AFTER PERMANENT VEGETATION IS ESTABLISHED.

THIS INSTALLATION OF EROSION AND SEDIMENTATION CONTROL MEASURES AND PRACTICES SHALL OCCUR PRIOR TO OR CONCURRENT WITH LAND DISTURBING ACTIVITIES.

24-HOUR CONTACT:
GARROW ALBERSON
PHONE: (912) 267-5540
EMAIL: GALBERSON@CITYOFBRUNSWICK-GA.GOV

TOTAL SITE AREA: ±40 ACRES
TOTAL DISTURBED AREA: ±33 ACRES

SILT FENCE AREA
DRAINAGE AREA = 32.26 ACRES (TO SILT FENCE)

SILT FENCE CALCULATION
SILT FENCE REQ'D = $100/0.25 \text{ AC} \times 32.26 \text{ AC} = 12,904 \text{ LF}$
SILT FENCE PROVIDED = 14,207 LF

LAUREN K RAINEY
Level II Certified Design Professional
CERTIFICATION NUMBER: 0000088324
ISSUED: 06/25/2019 EXPIRES: 06/25/2022

LIMITS OF DISTURBANCE
SILT FENCE (SEE PLAN)
PROPOSED GRADE
EXISTING GRADE

TYPICAL LIMITS OF DISTURBANCE SECTION

GEORGIA811
Utilities Protection Center, Inc.
Know what's below.
Call before you dig.

C-401 PHASE I C-407 PHASE II C-413 PHASE III	C-402 PHASE I C-408 PHASE II C-414 PHASE III	C-403 PHASE I C-409 PHASE II C-415 PHASE III
C-404 PHASE I C-410 PHASE II C-416 PHASE III	C-405 PHASE I C-411 PHASE II C-417 PHASE III	C-406 PHASE I C-412 PHASE II C-418 PHASE III

0 40' 100' 200' 400'
1"=200'-0"

28 May 2020

-  **GSWCC** GEORGIA SOIL AND WATER
CONSERVATION COMMISSION
- Lauren K Rainey**
- Level II Certified Design Professional**
- CERTIFICATION NUMBER: **0000088324**
- ISSUED: **06/25/2019** EXPIRES: **06/25/2022**



C-401 PHASE I
C-407 PHASE II
C-413 PHASE III


C-402 PHASE I
C-408 PHASE II
C-414 PHASE III

C-403 PHASE I
C-409 PHASE II
C-415 PHASE III


C-404 PHASE I
C-410 PHASE II
C-416 PHASE III

C-405 PHASE I
C-411 PHASE II
C-417 PHASE III

C-406 PHASE I
C-412 PHASE II
C-418 PHASE III


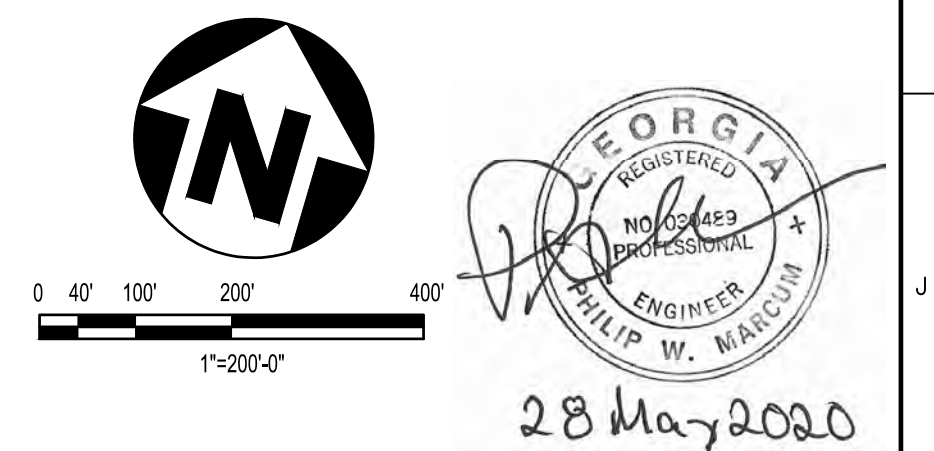


REVISIONS										BY	AP.	NO	DATE	REVISIONS	BY	AP.	NOTICE	DWG. NO.	REFERENCE DRAWINGS	T STREET LANDFILL CLOSURE	GLYNN COUNTY	BRUNSWICK, GA	OVERALL ES&PC PLAN																																																																																																																																																																																																																																																																																																																																																																																																																																																																																																																																																																																																																																																																																																																																																																																																																																																																																																																																																																																																																																																																																																																																																																																																																																																																																																																																																												

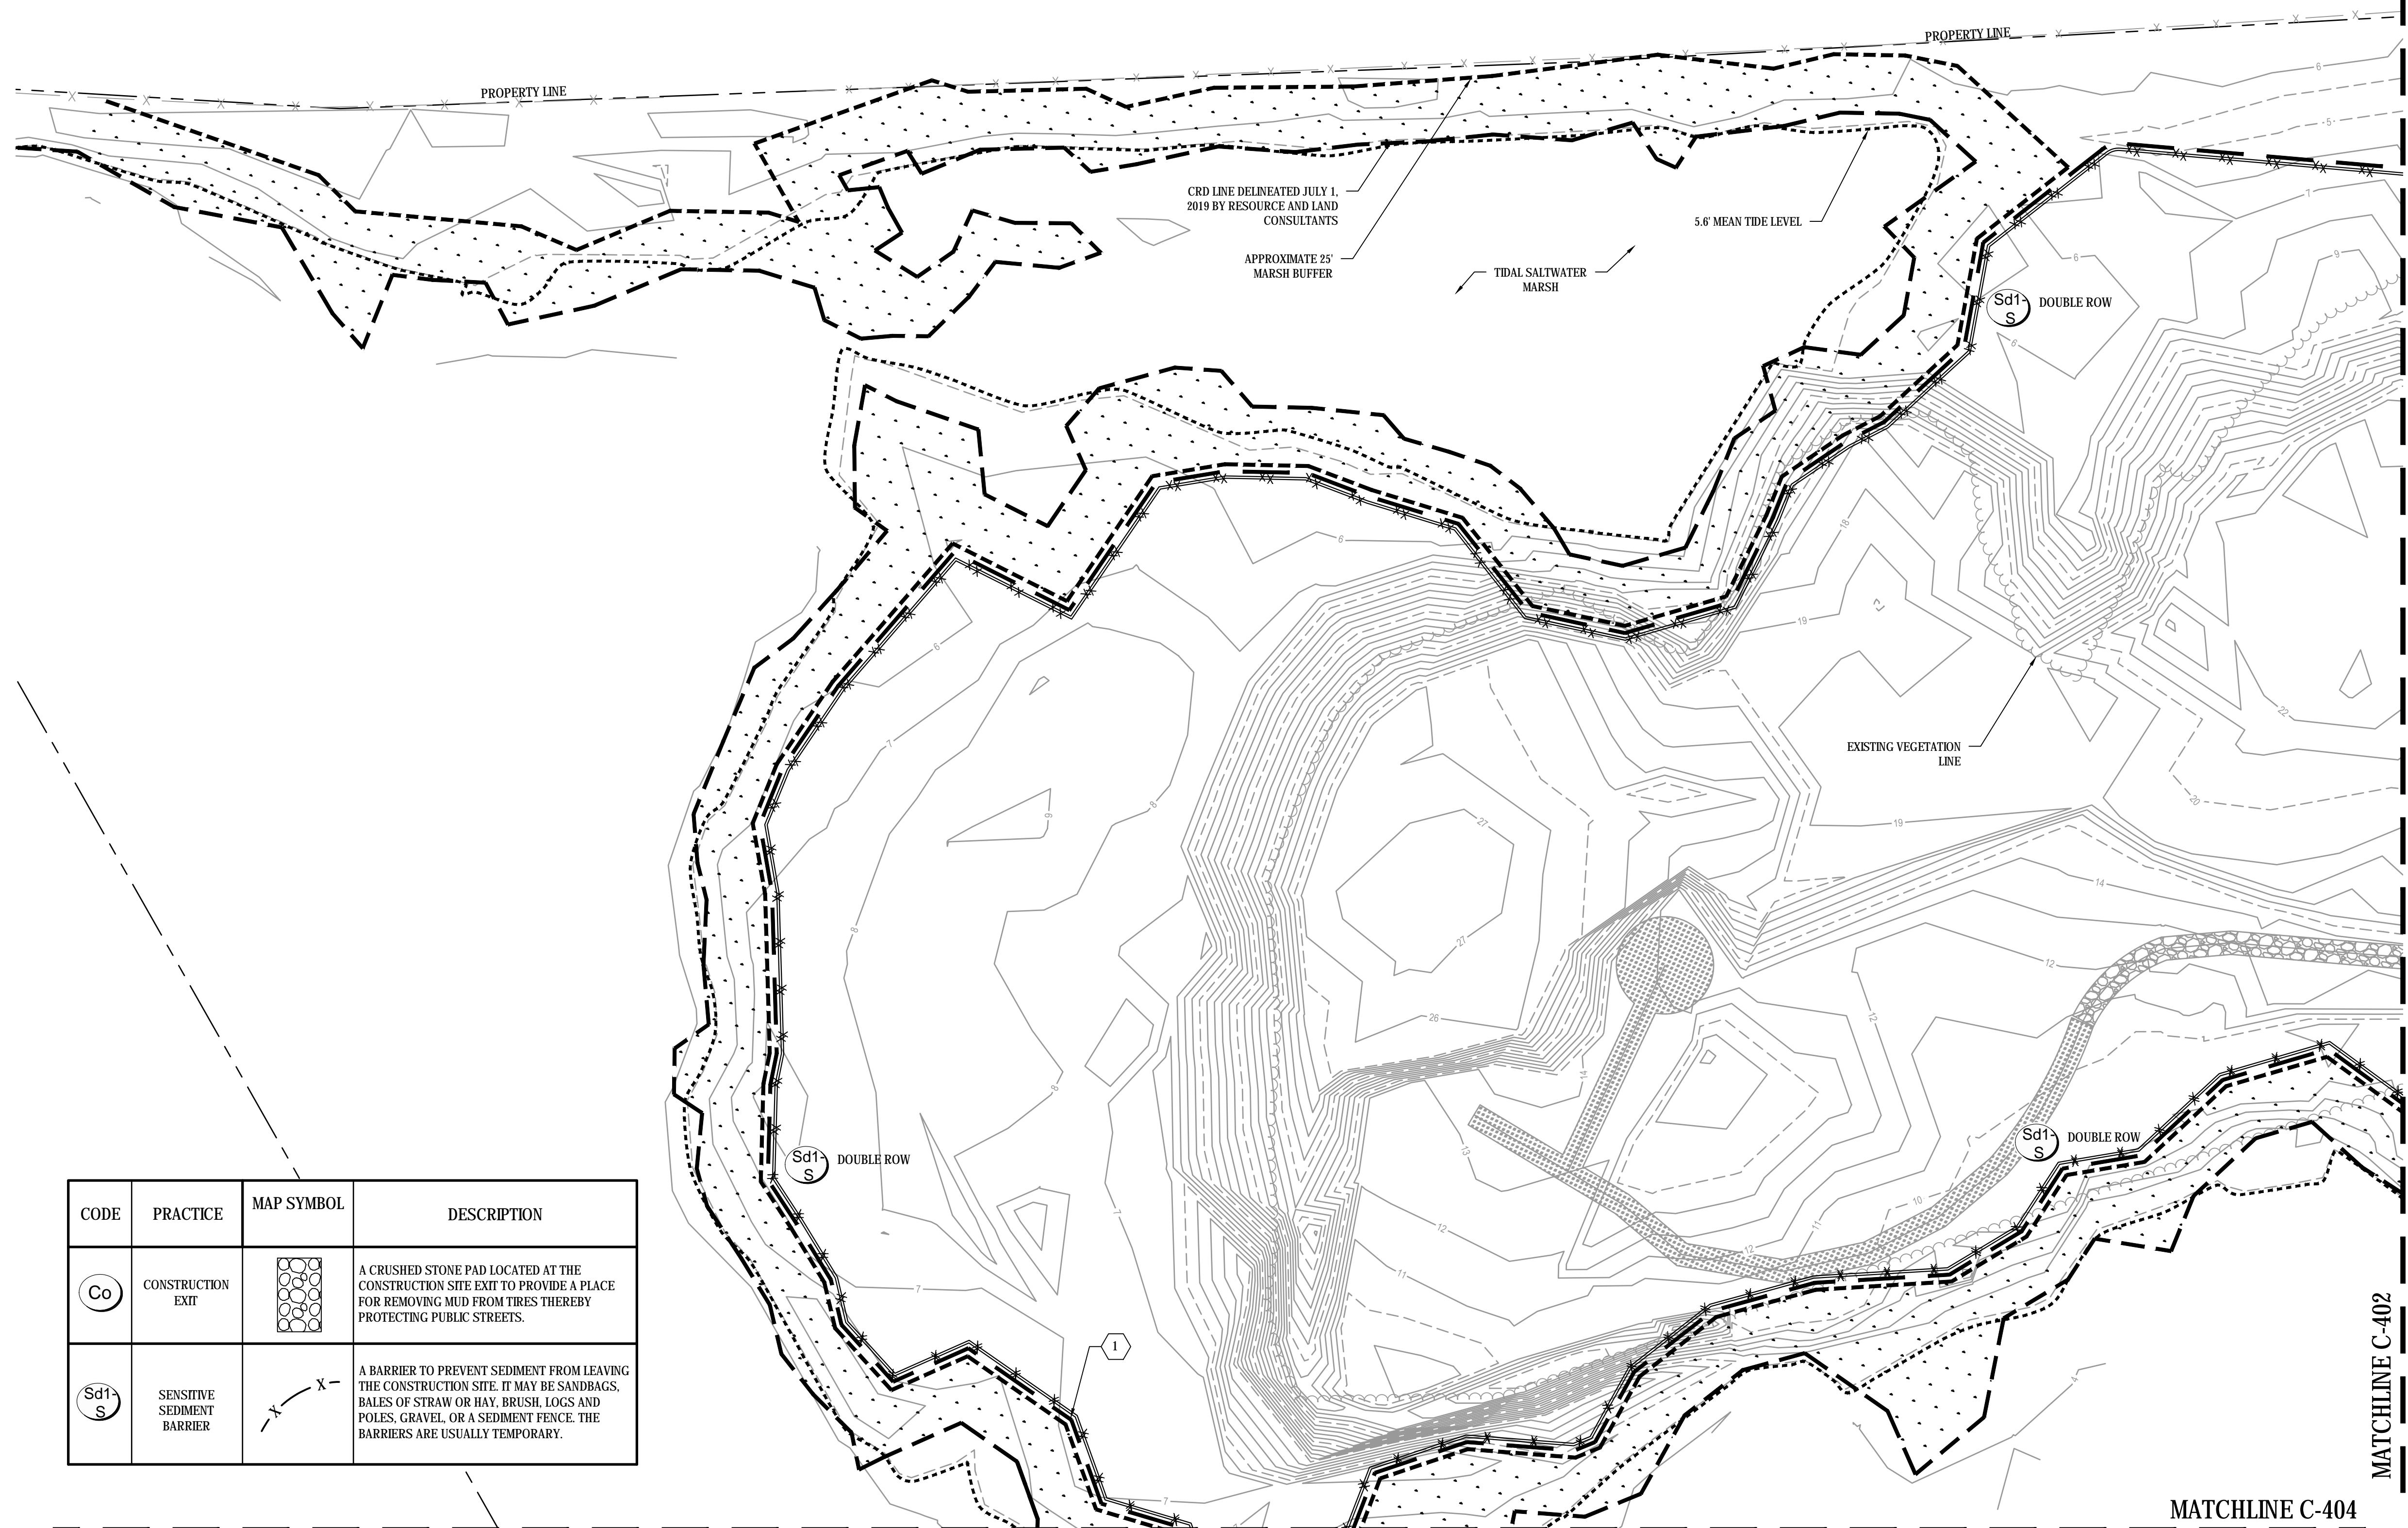


- CONSTRUCTION SEQUENCE
1. INSTALL CONSTRUCTION ENTRANCE.
 2. CLEAR AND GRUB FOR SILT FENCE AND INSTALL SILT FENCE.
 3. PERFORM SITE DEMOLITION ACTIVITIES AS SHOWN ON SHEET 4.
 4. COMPLETE CLEARING AND GRUBBING UP TO THE PROPOSED LIMITS OF CONSTRUCTION.
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 6. INSTALL FINAL COVER IN ACCORDANCE WITH THE FINISH GRADES.
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 9. INSTALL RIP RAP ALONG THE TOE OF SLOPE OF THE LANDFILL.
 10. REMOVE SEDIMENT CONTROLS AFTER PERMANENT VEGETATION IS ESTABLISHED.

- KEY NOTES:
- 1 LIMITS OF DISTURBANCE
 - 2 TYPE 3 RIP RAP

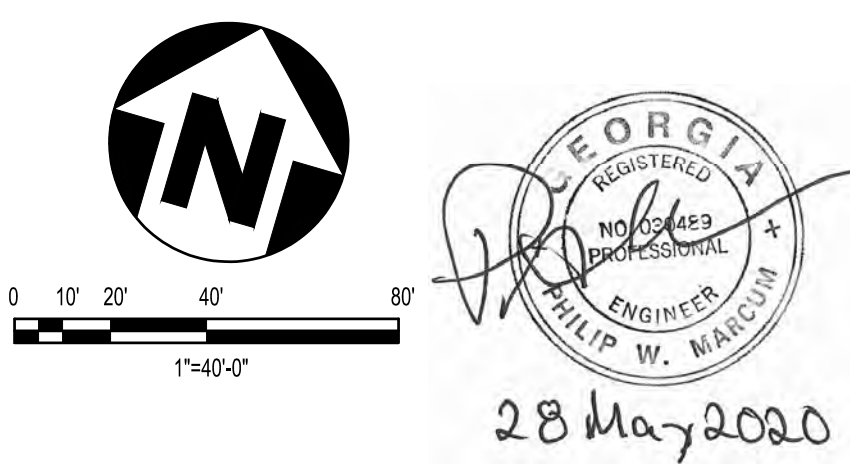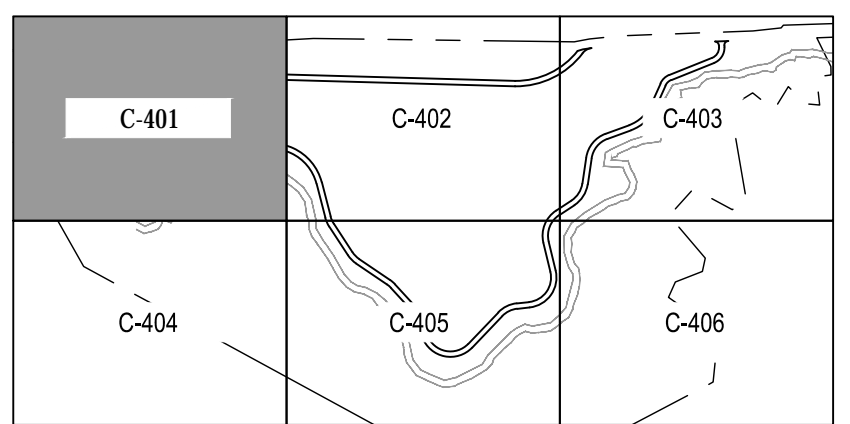


CODE	PRACTICE	MAP SYMBOL	DESCRIPTION
Co	CONSTRUCTION EXIT		A CRUSHED STONE PAD LOCATED AT THE CONSTRUCTION SITE EXIT TO PROVIDE A PLACE FOR REMOVING MUD FROM TIRES THEREBY PROTECTING PUBLIC STREETS.
Sd1 S	SENSITIVE SEDIMENT BARRIER		A BARRIER TO PREVENT SEDIMENT FROM LEAVING THE CONSTRUCTION SITE. IT MAY BE SANDBAGS, BALES OF STRAW OR HAY, BRUSH, LOGS AND POLES, GRAVEL, OR A SEDIMENT FENCE. THE BARRIERS ARE USUALLY TEMPORARY.

NO	DATE	REVISIONS	BY	AP.	NO	DATE	REVISIONS	BY	AP.	NOTICE	DWG. NO.	REFERENCE DRAWINGS			T STREET LANDFILL CLOSURE			PHASE I INITIAL ES&PC PLAN				
										This drawing has not been published and is the sole property of T STREET LANDFILL STEERING GROUP and is lent to the borrower for their confidential use only; and in consideration of the loan of this drawing the borrower promises and agrees that it shall not be reproduced, copied, lent or otherwise disposed of directly or indirectly, nor used for any purpose other than for which it is specifically furnished.					GLYNN COUNTY							
															BRUNSWICK, GA							
0	20MAY20	ISSUED FOR CONSTRUCTION	LKR	PWM														ENG. LKR	JOB NO. 6123-20-1372	DATE 05/19/2020		REV.
A	07MAY20	FOR OWNER REVIEW	LKR	PWM														DR.	W. O.	DWG. NO.		---
																		CH.		6123-20-1372-C-401		
																		AP. PWM				
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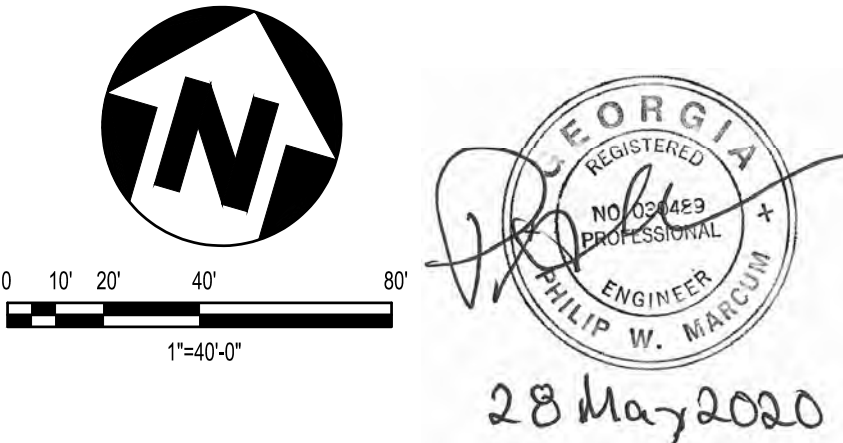


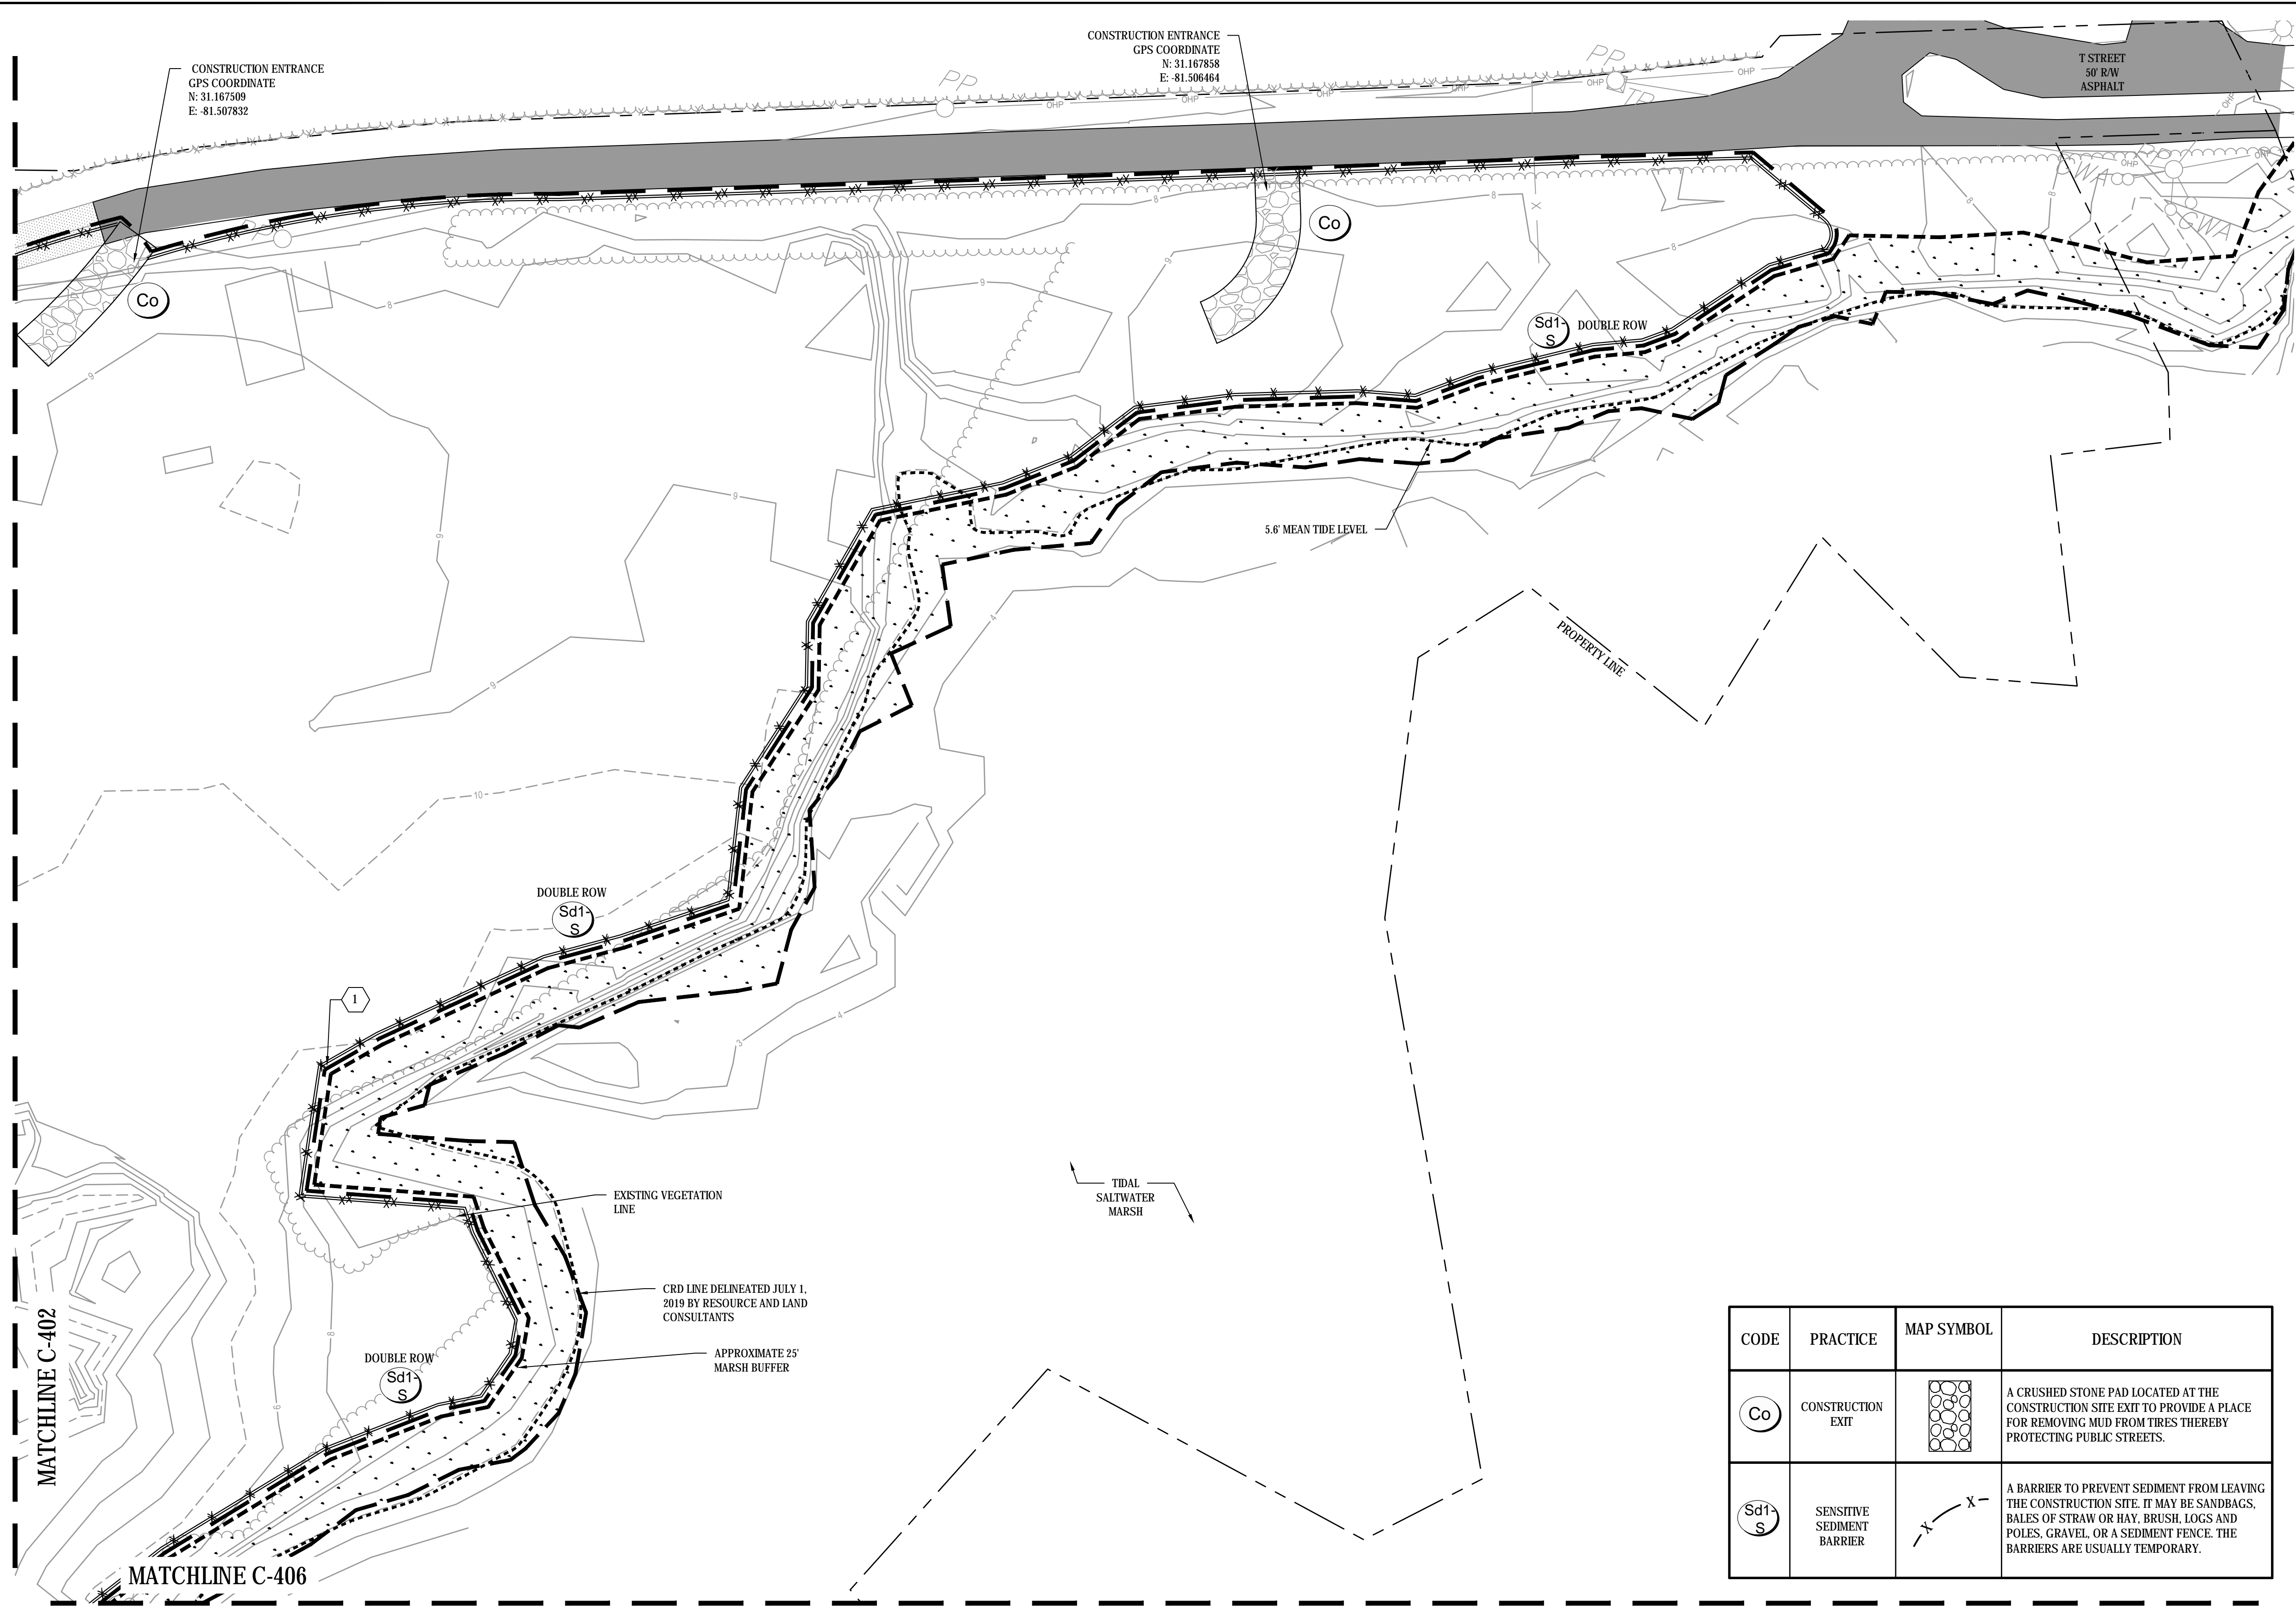- CONSTRUCTION SEQUENCE
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 - 2 TYPE 3 RIP RAP



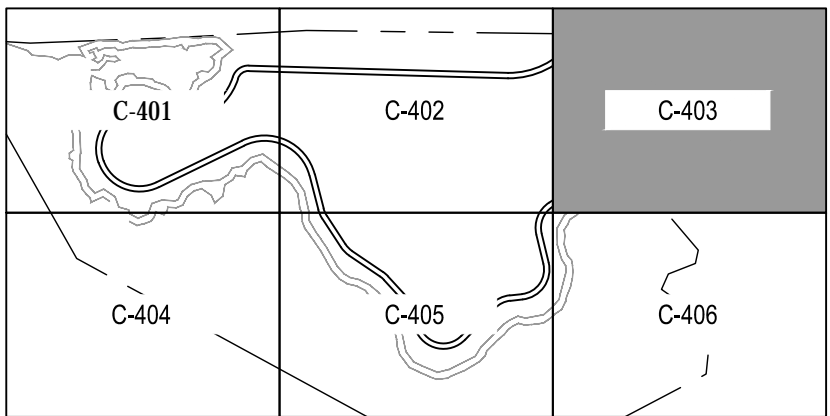

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													BRUNSWICK, GA																								
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A	07MAY20	FOR OWNER REVIEW	LKR	PWM												DR.	W. O.	DWG. NO.	REV.																		
																CH.		6123-20-1372-C-403																			
																AP. PWM		----																			
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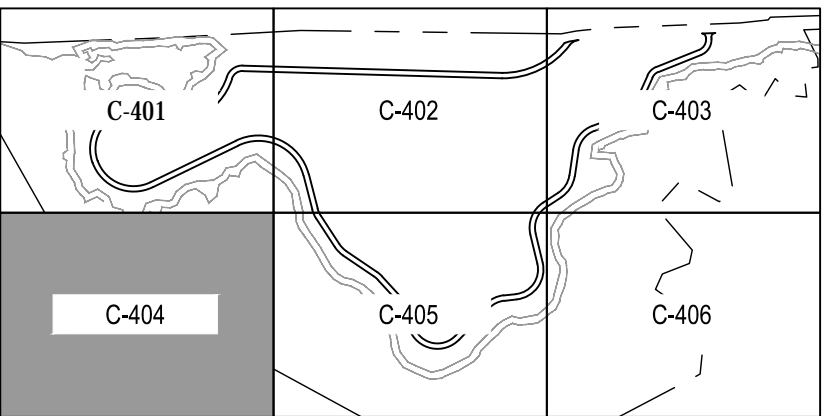


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KEY NOTES:

- | | |
|---|-----------------------|
| 1 | LIMITS OF DISTURBANCE |
| 2 | TYPE 3 RIP RAP |




28 May 2020

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0	20MAY20	ISSUED FOR CONSTRUCTION	LKR	PWM	▲																
A	07MAY20	FOR OWNER REVIEW	LKR	PWM	▲																
1	2	3	4	5	6	7	8	9	10	11	12	13	14	15	16	17	18	19			

MATCHLINE C-402


MATCHLINE C-404

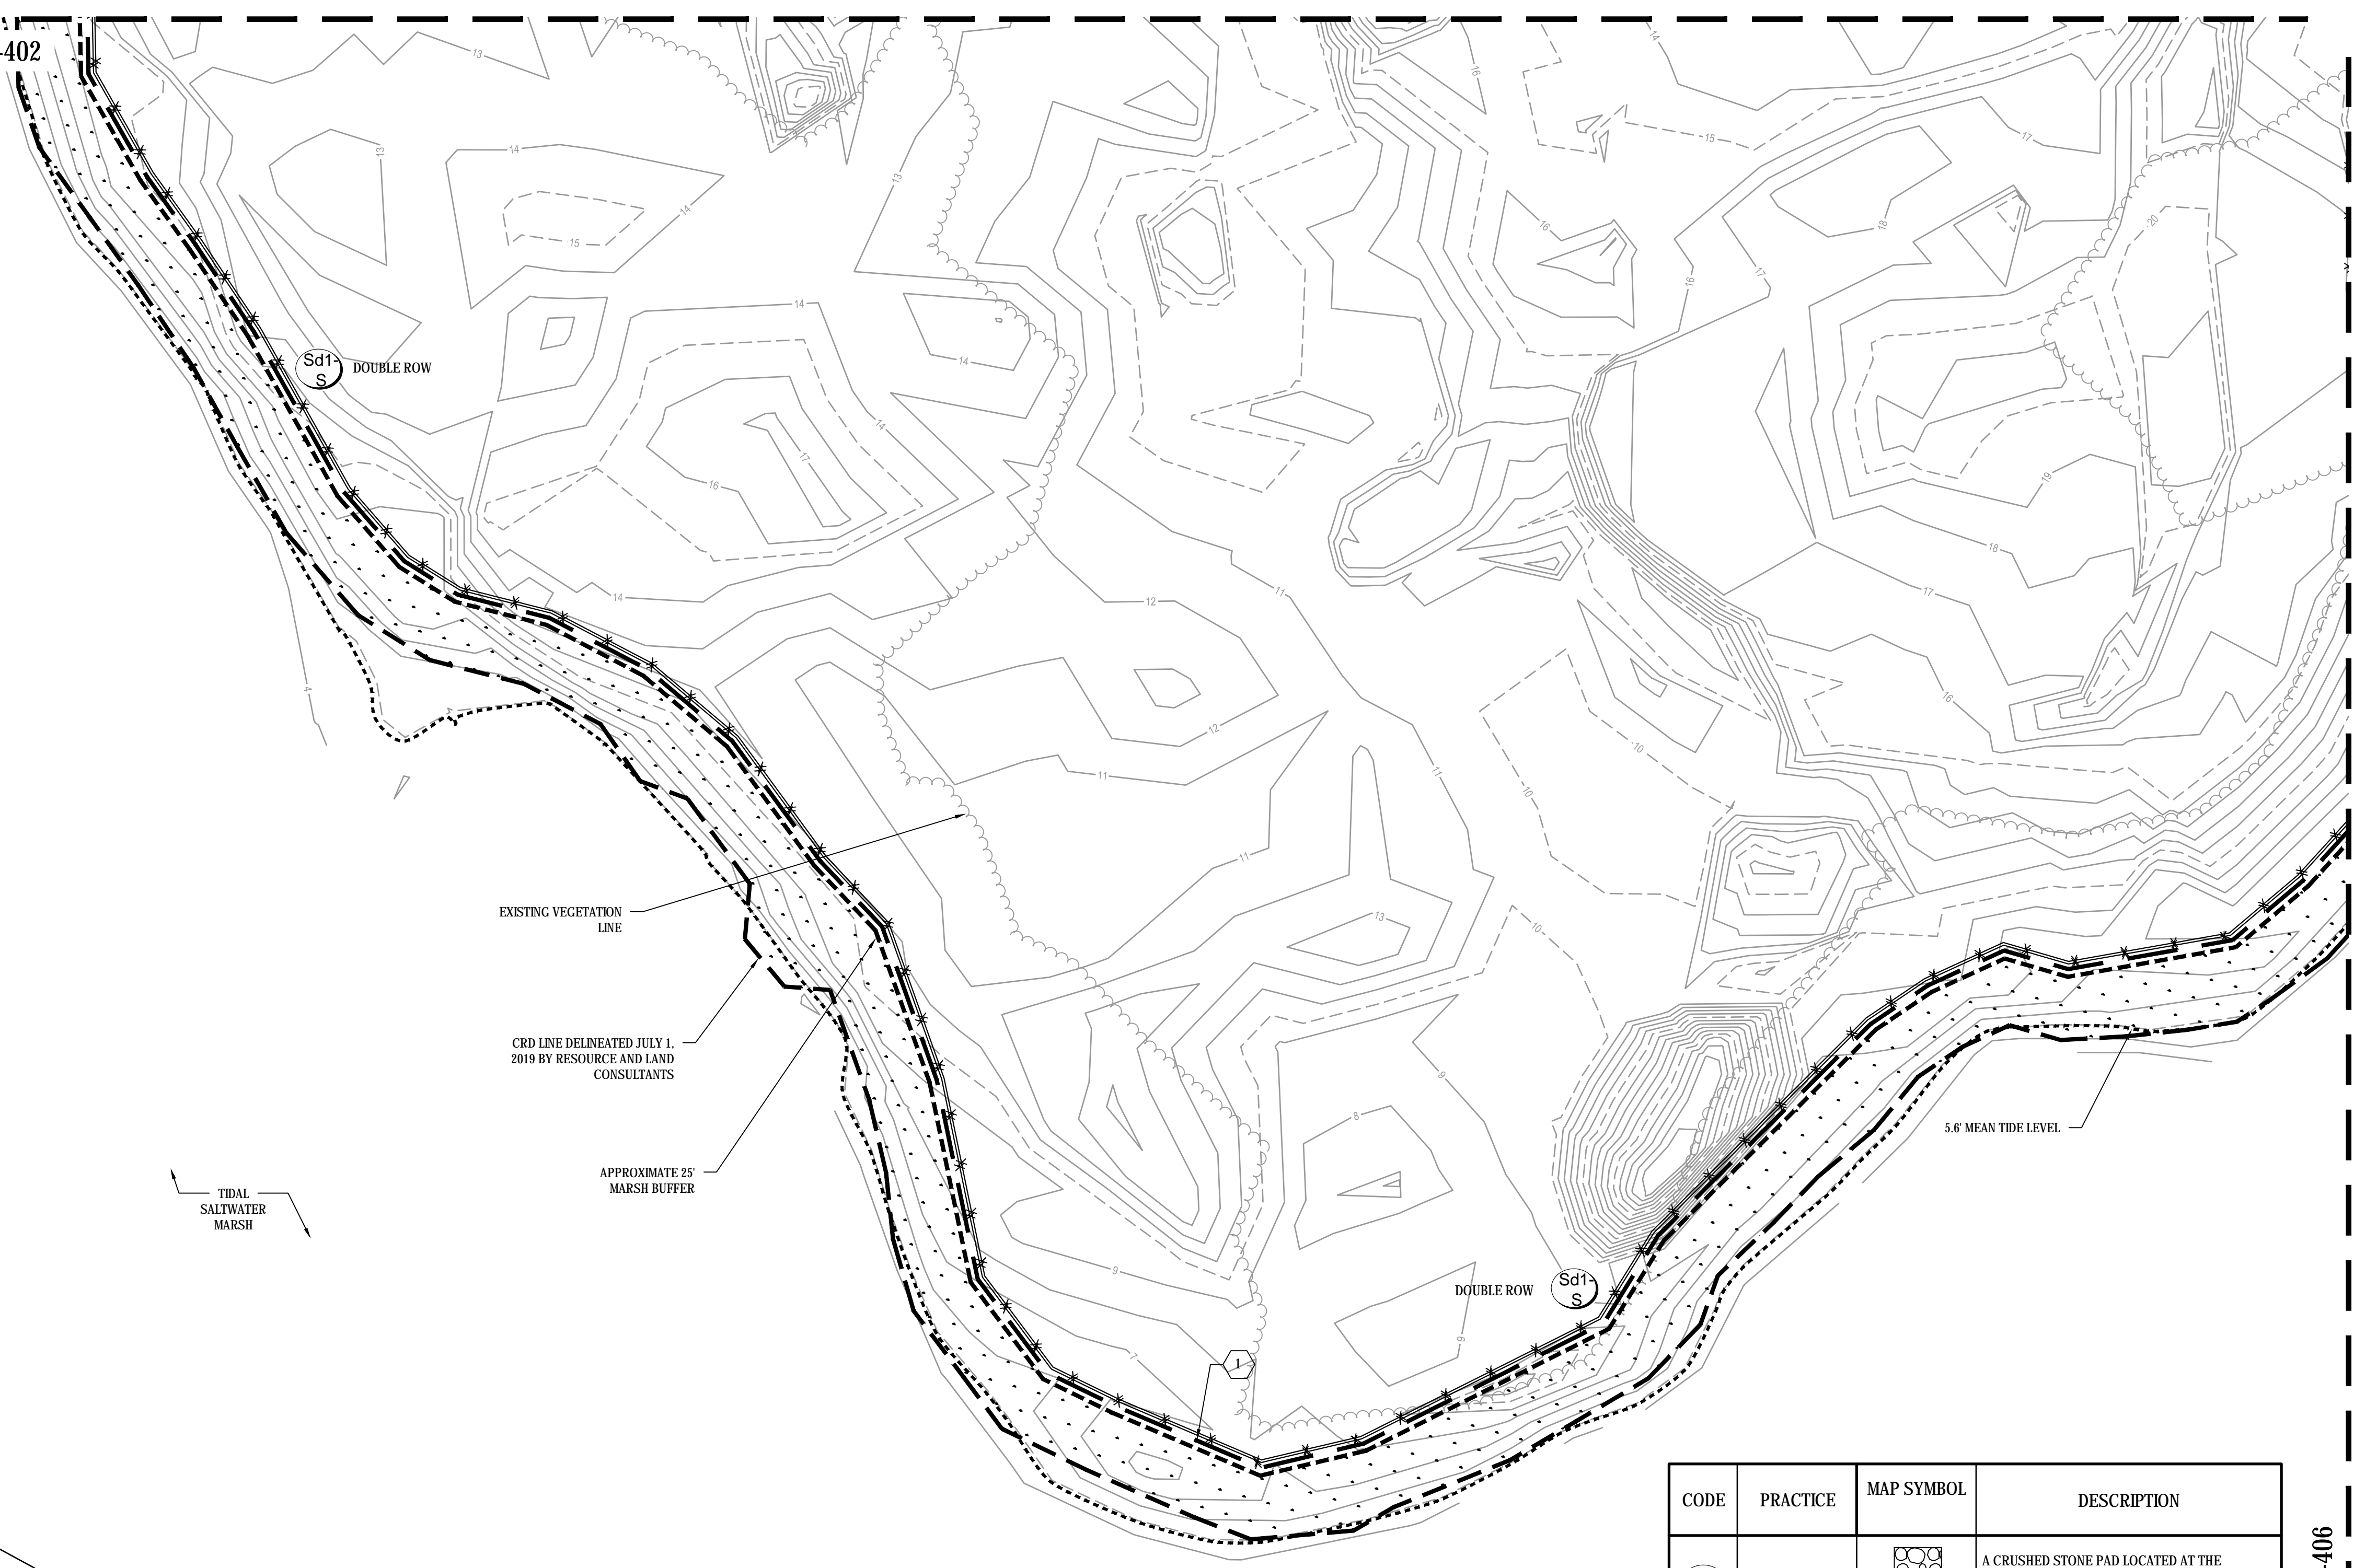

- CONSTRUCTION SEQUENCE
1. INSTALL CONSTRUCTION ENTRANCE.
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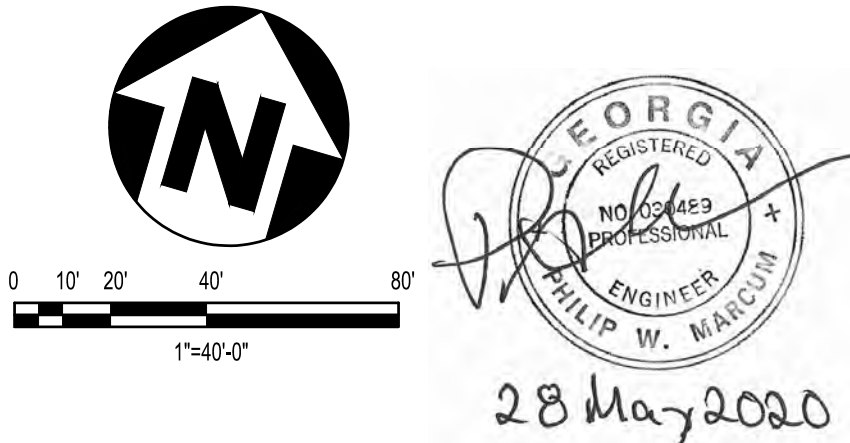
KEY NOTES:

- 1 LIMITS OF DISTURBANCE
- 2 TYPE 3 RIP RAP

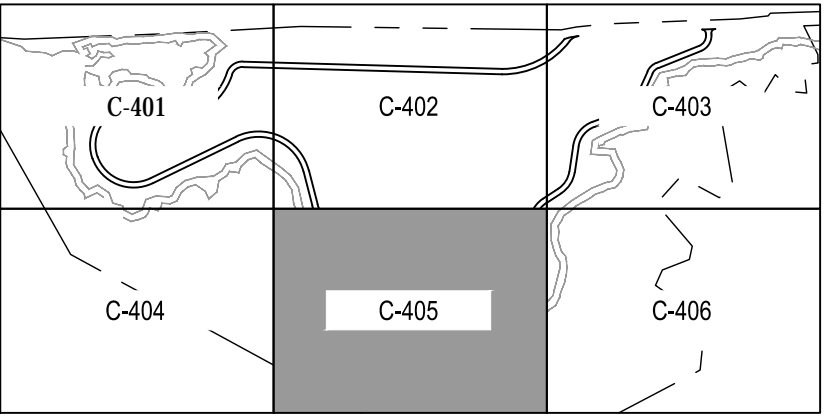


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MATCHLINE C-406



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A	07MAY20	FOR OWNER REVIEW	LKR	PWM																																		
1		2			3		4			5		6		7		8		9		10		11		12		13		14		15		16		17		18		19

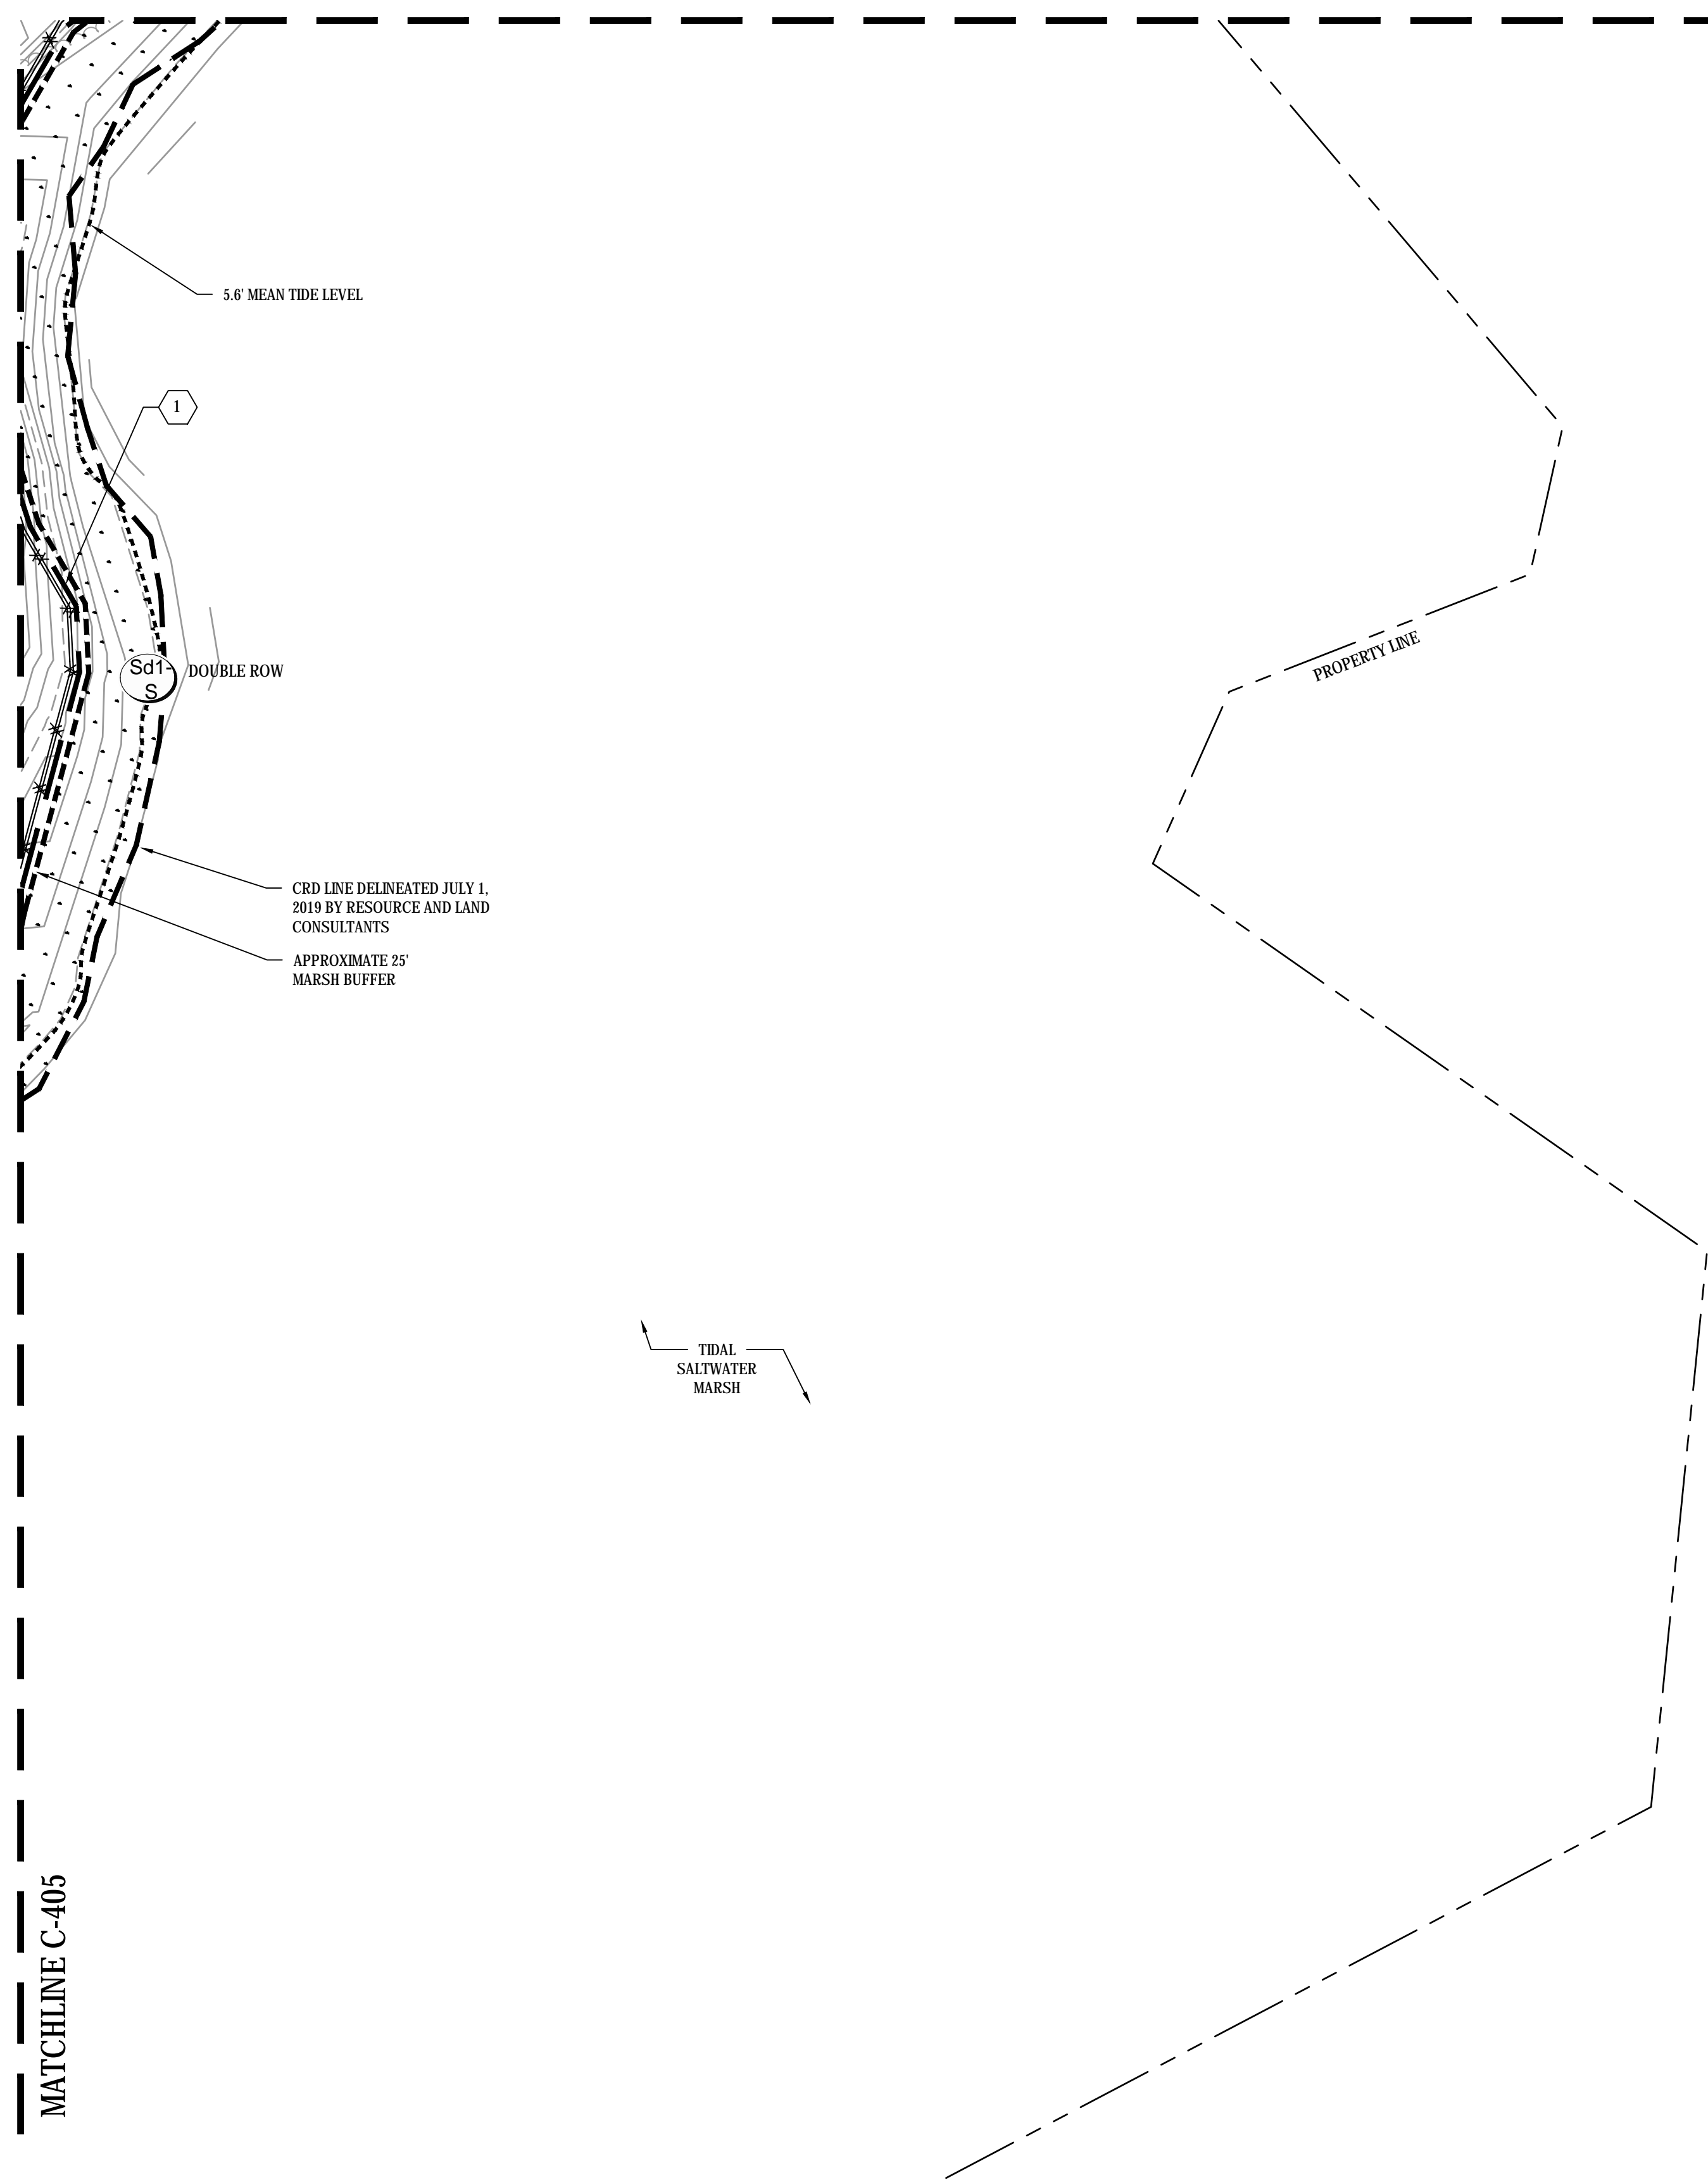



MATCHLINE C-403

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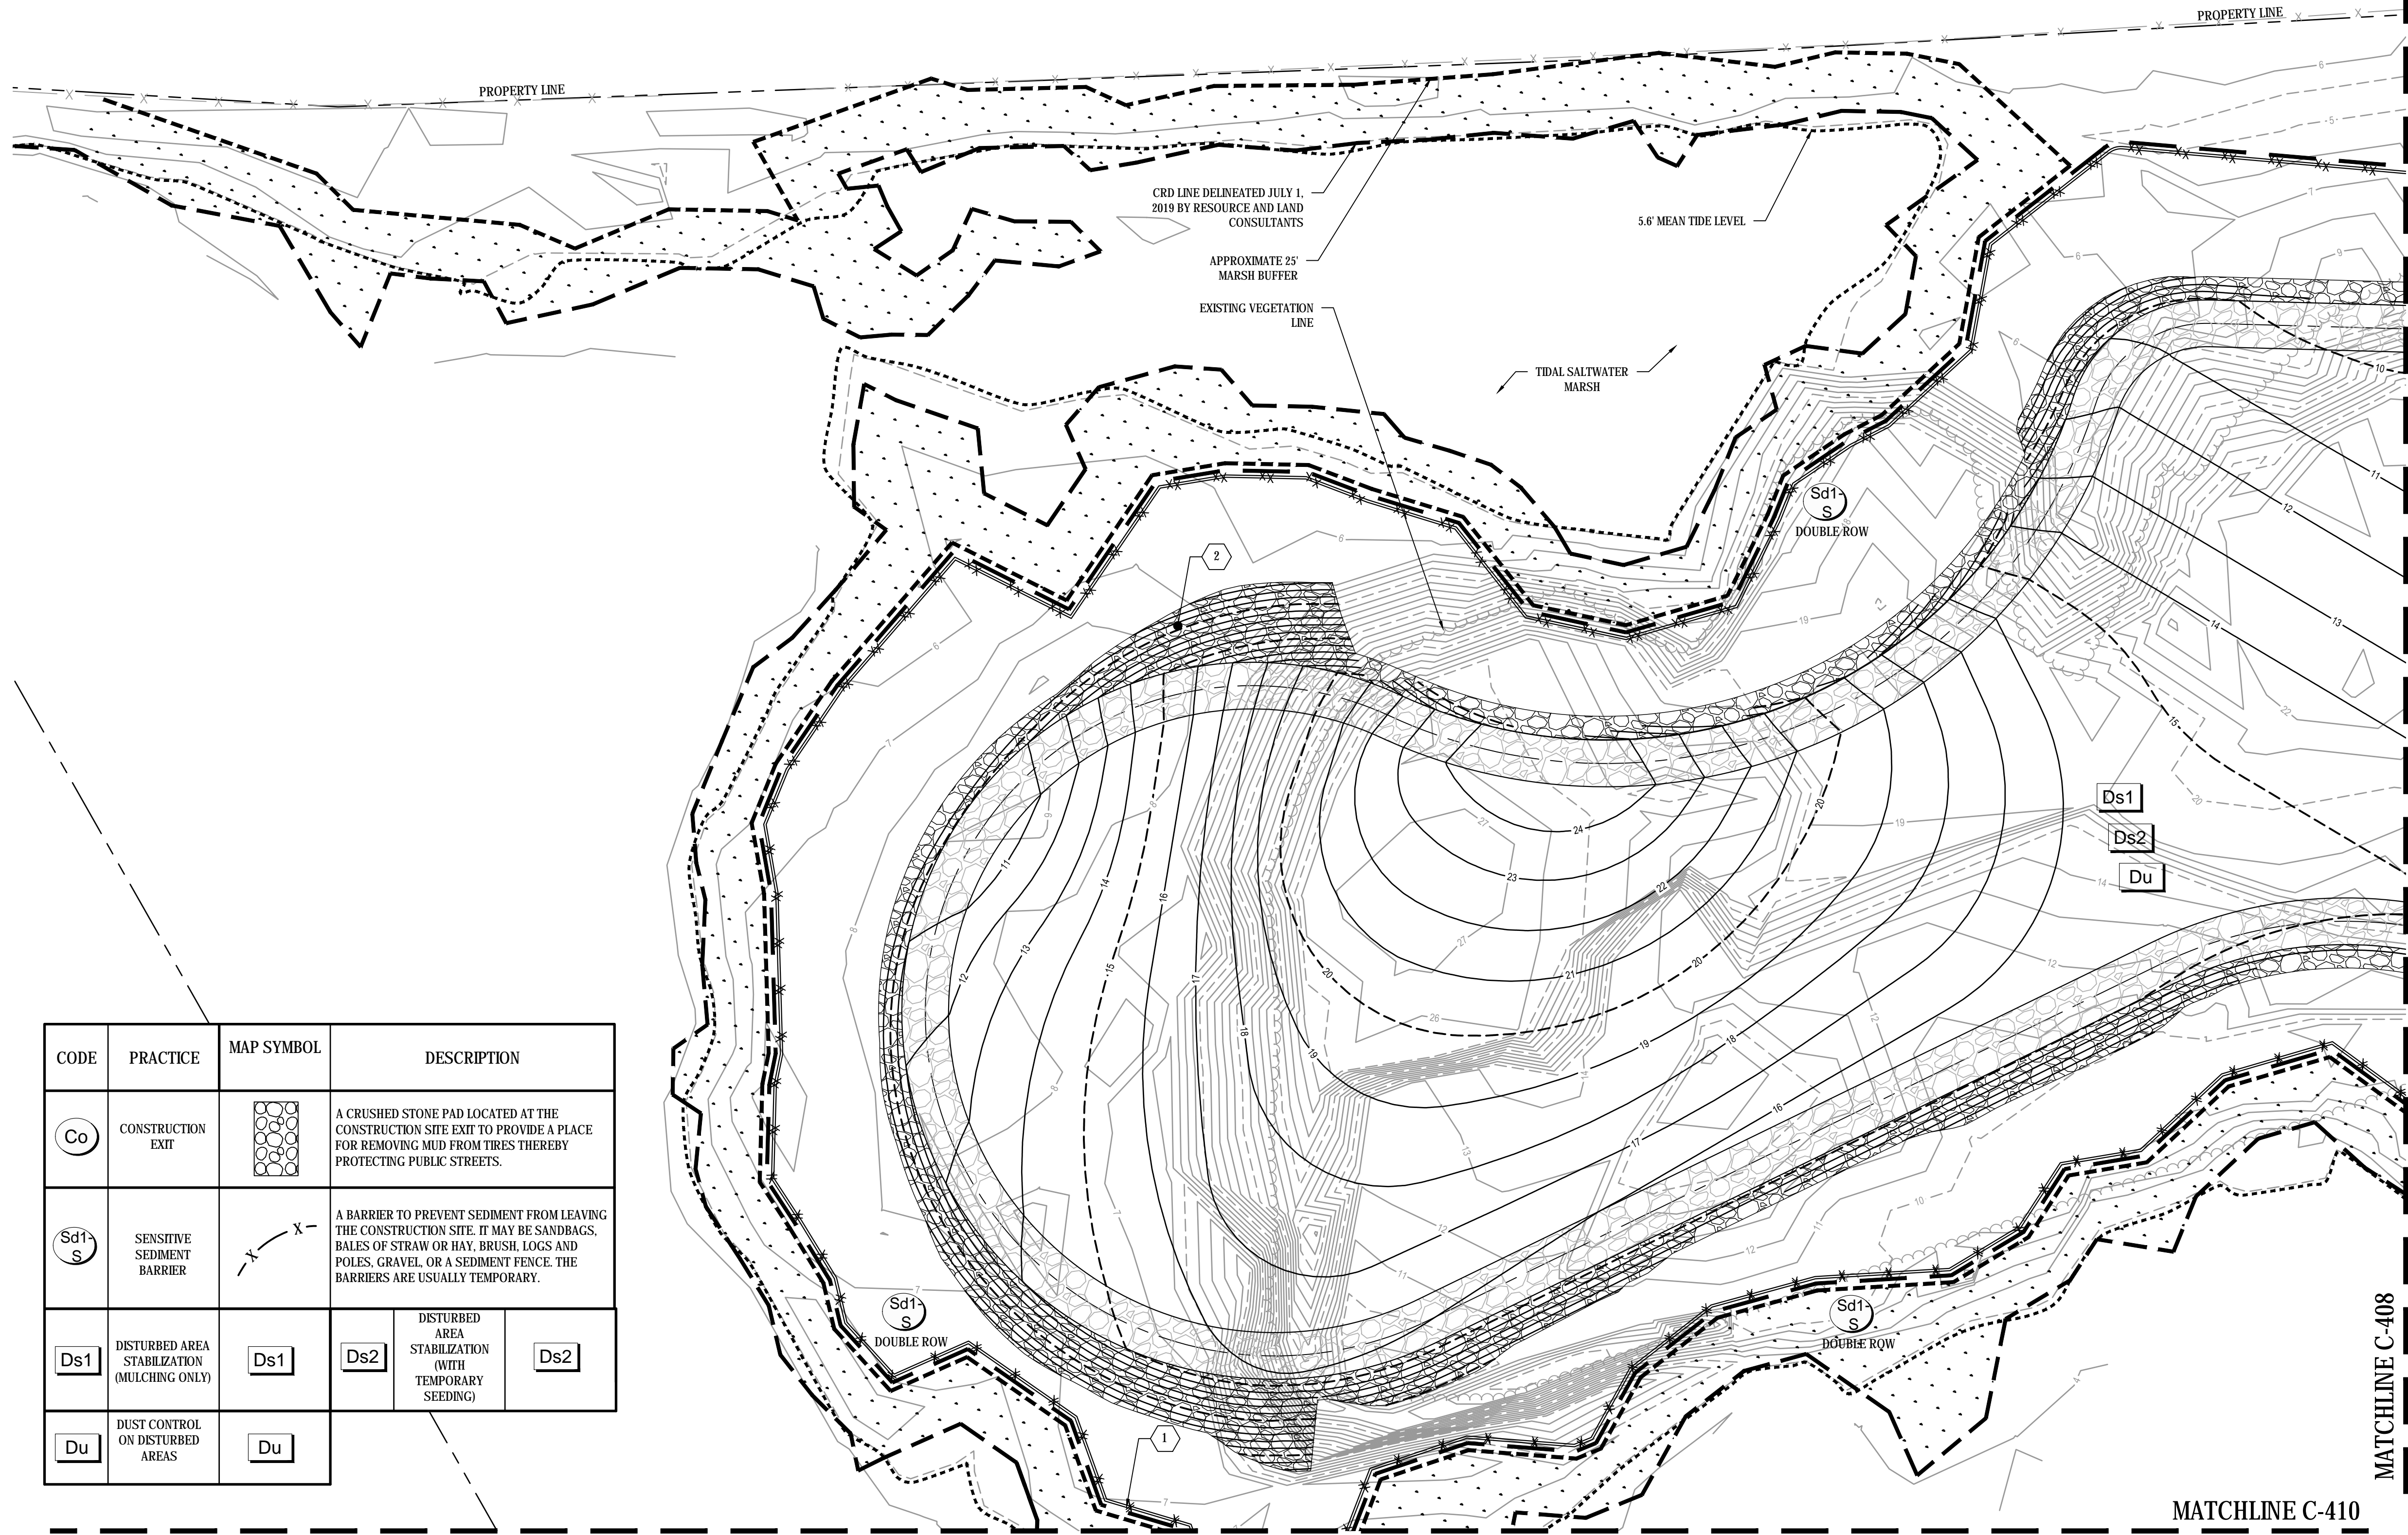
- CONSTRUCTION SEQUENCE
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KEY NOTES:

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2 TYPE 3 RIP RAP





NO	DATE	REVISIONS	BY	AP.	NO	DATE	REVISIONS	BY	AP.	NOTICE	DWG. NO.	REFERENCE DRAWINGS	<i>T STREET LANDFILL CLOSURE</i> GLYNN COUNTY BRUNSWICK, GA		PHASE I INITIAL ES&PC PLAN			
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															DR.	W. O.	DWG. NO.	REV.
															CH.		6123-20-1372-C-406	----
															AP. PWM			
0	20MAY20	ISSUED FOR CONSTRUCTION	LKR	PWM														
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Ds1	DISTURBED AREA STABILIZATION (MULCHING ONLY)	Ds1	Ds2	DISTURBED AREA STABILIZATION (WITH TEMPORARY SEEDING)	Ds2
Du	DUST CONTROL ON DISTURBED AREAS	Du			

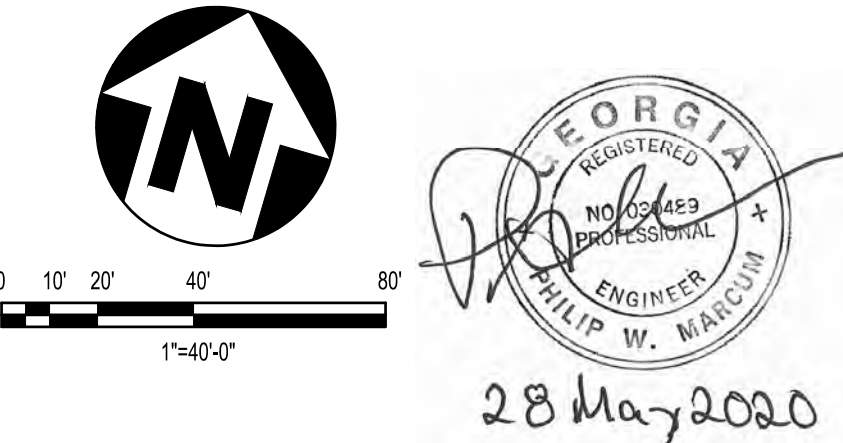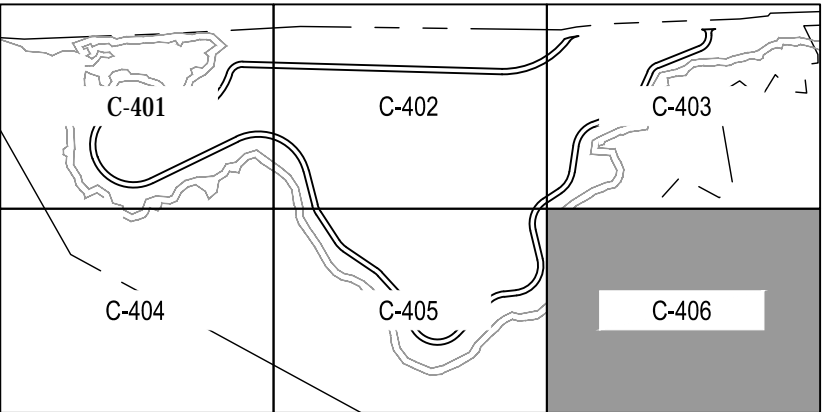- CONSTRUCTION SEQUENCE
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- KEY NOTES:
- 1 LIMITS OF DISTURBANCE
 - 2 TYPE 3 RIP RAP



NO	DATE	REVISIONS	BY	AP.	NO	DATE	REVISIONS	BY	AP.	NOTICE	DWG. NO.	REFERENCE DRAWINGS	T STREET LANDFILL CLOSURE		PHASE II INTERMEDIATE ES&PC PLAN			
0	20MAY20	ISSUED FOR CONSTRUCTION	LKR	PWM						This drawing has not been published and is the sole property of T STREET LANDFILL STEERING GROUP and is lent to the borrower for their confidential use only; and in consideration of the loan of this drawing the borrower promises and agrees that it shall not be reproduced, copied, lent or otherwise disposed of directly or indirectly, nor used for any purpose other than for which it is specifically furnished.			GLYNN COUNTY		ENG. LKR	JOB NO. 6123-20-1372	DATE 05/19/2020	REV. ---
A	07MAY20	FOR OWNER REVIEW	LKR	PWM									BRUNSWICK, GA		DR. W. O.	DWG. NO.		
															CH. PWM	6123-20-1372-C-407		
															AP. PWM			




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			DISTURBED AREA STABILIZATION (WITH TEMPORARY SEEDING)
			Ds2

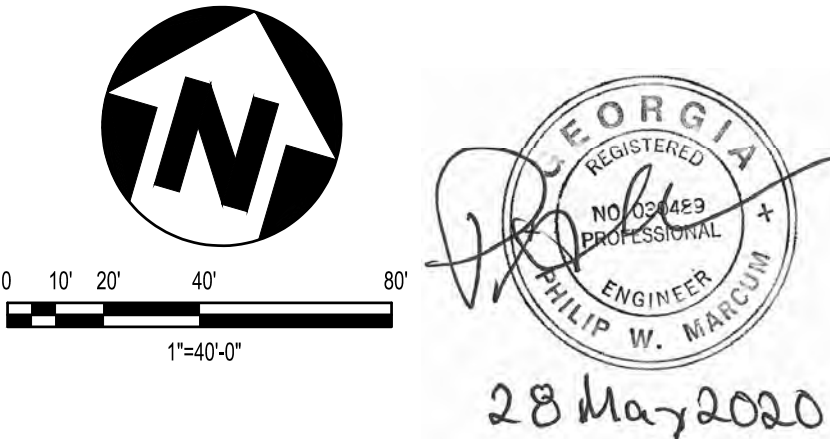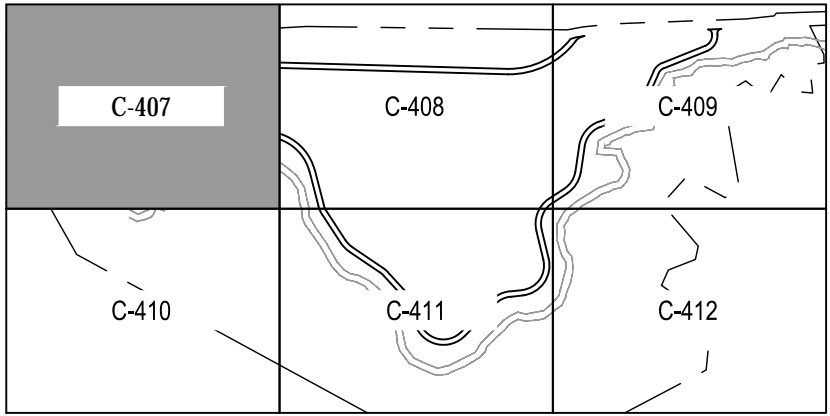Du	DUST CONTROL ON DISTURBED AREAS	Du
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 9. INSTALL RIP RAP ALONG THE TOE OF SLOPE OF THE LANDFILL.
 10. REMOVE SEDIMENT CONTROLS AFTER PERMANENT VEGETATION IS ESTABLISHED.

KEY NOTES:

- 1 LIMITS OF DISTURBANCE
- 2 TYPE 3 RIP RAP

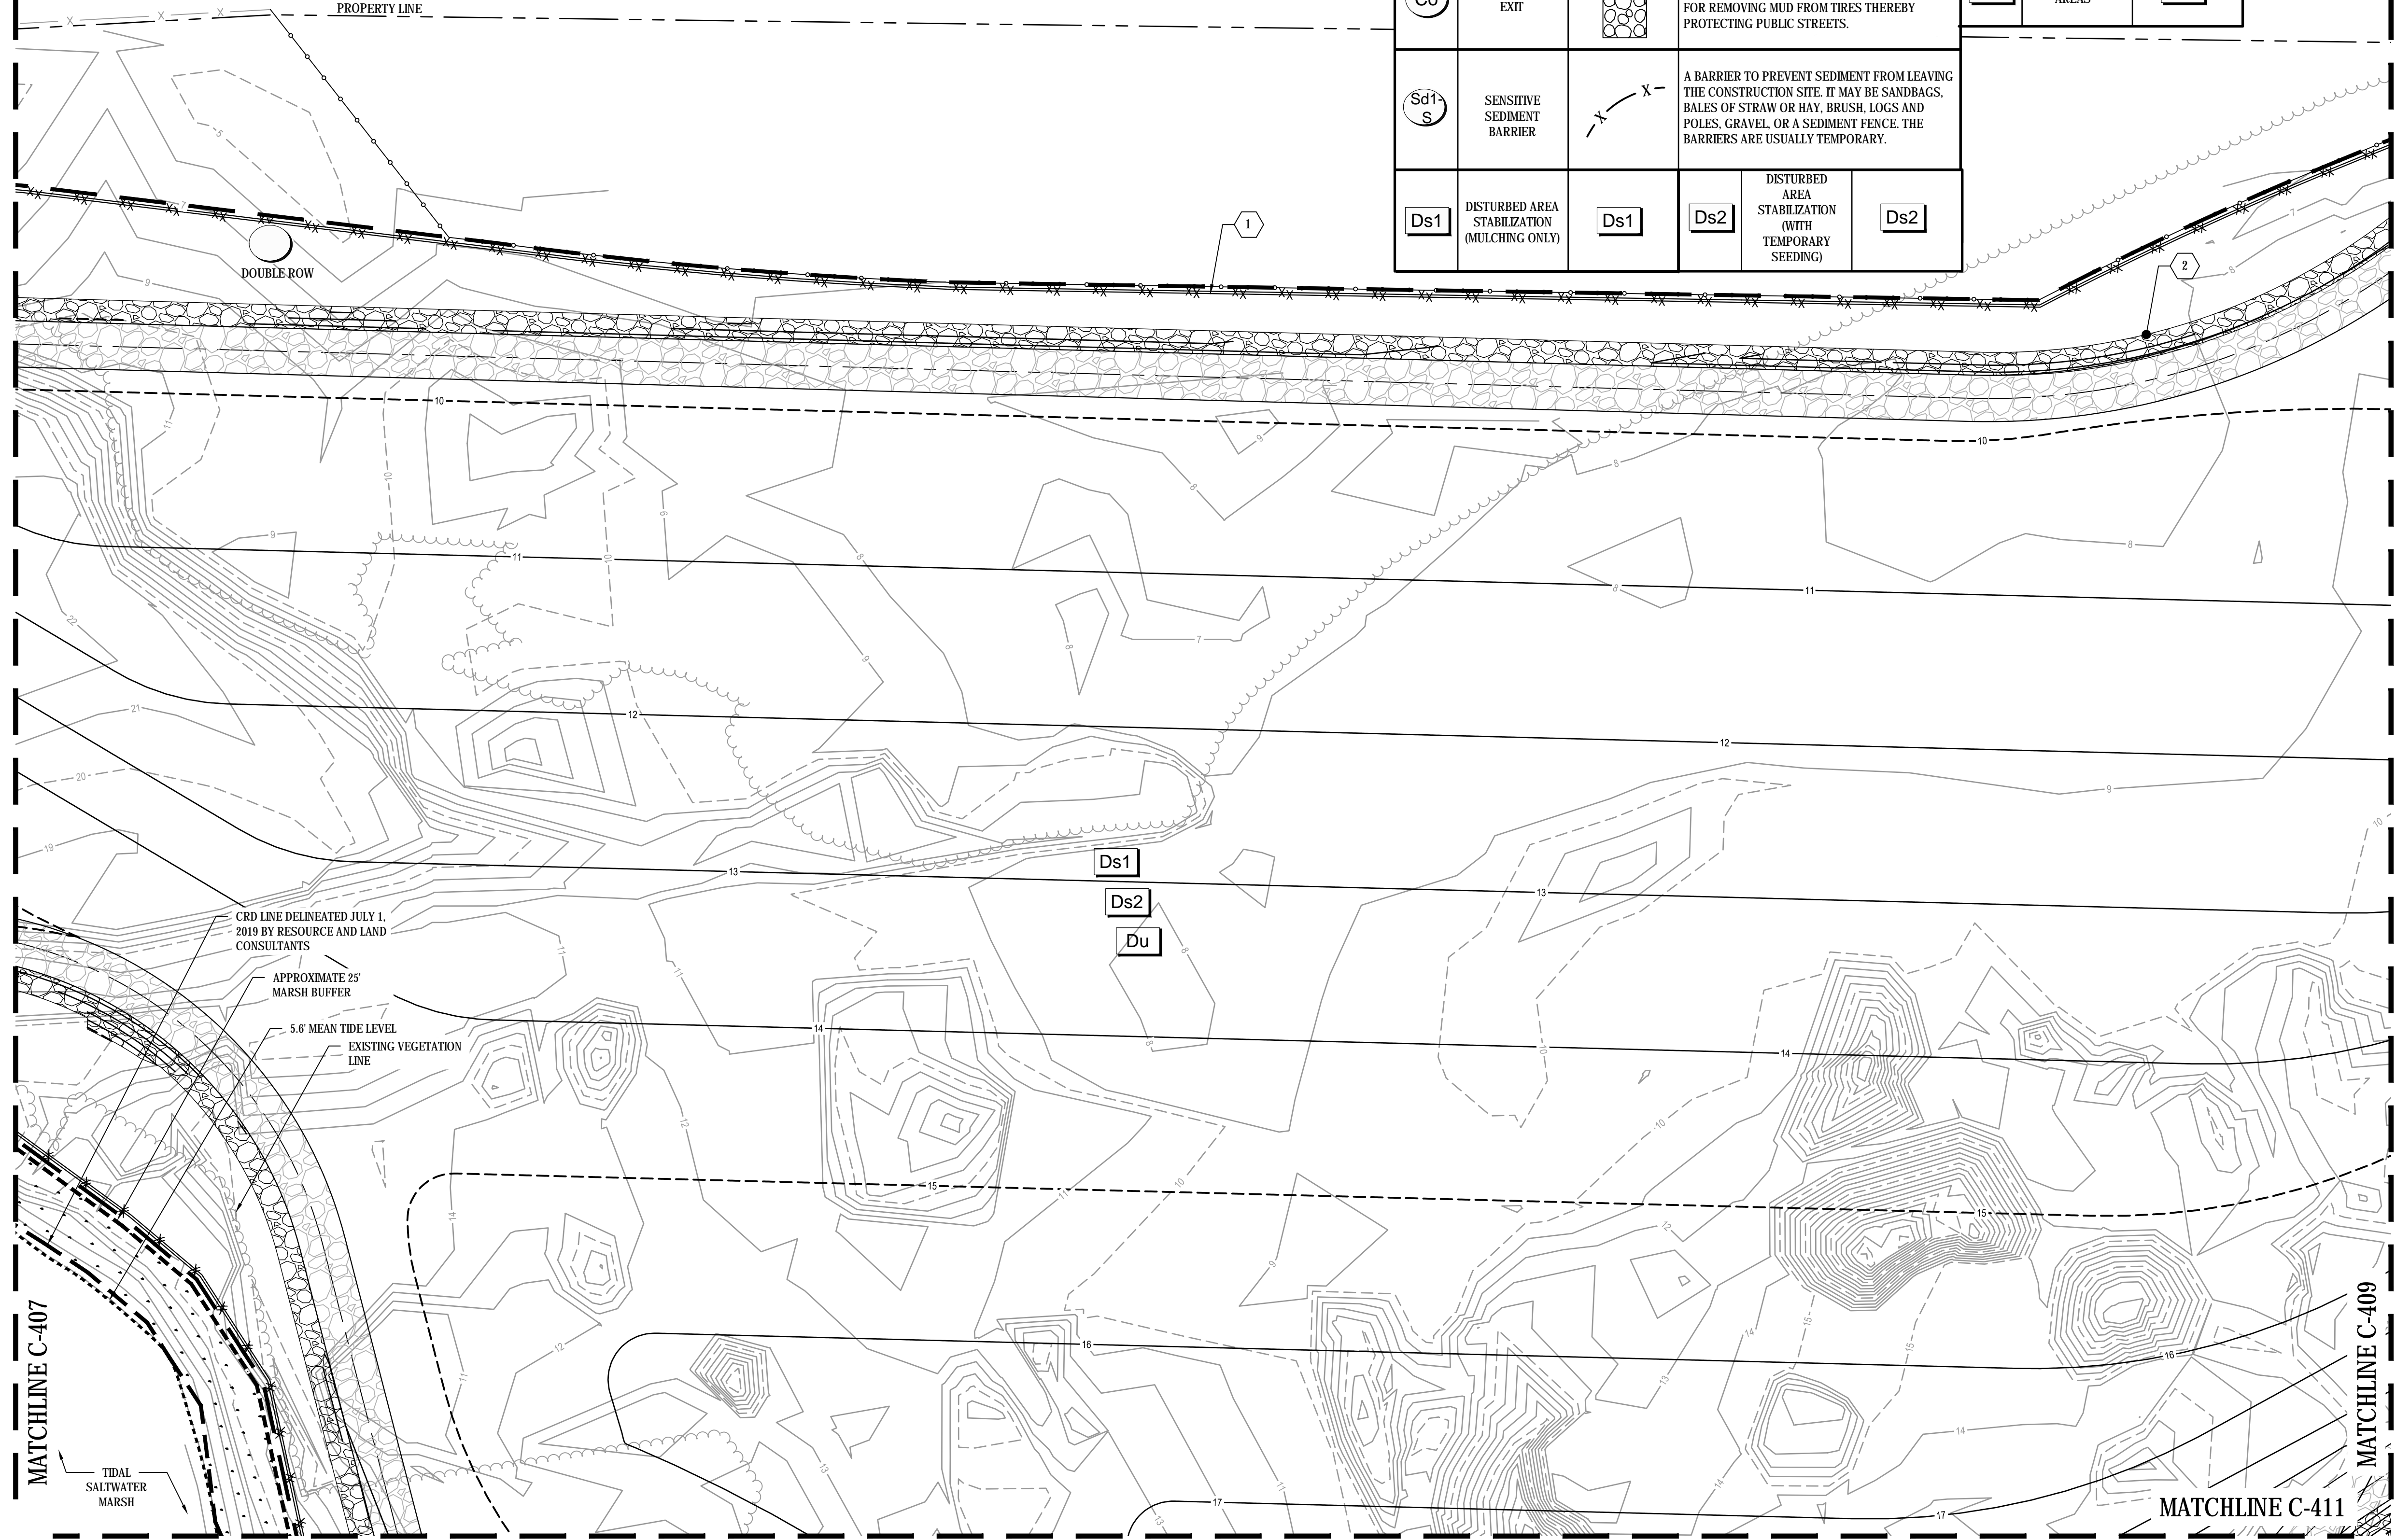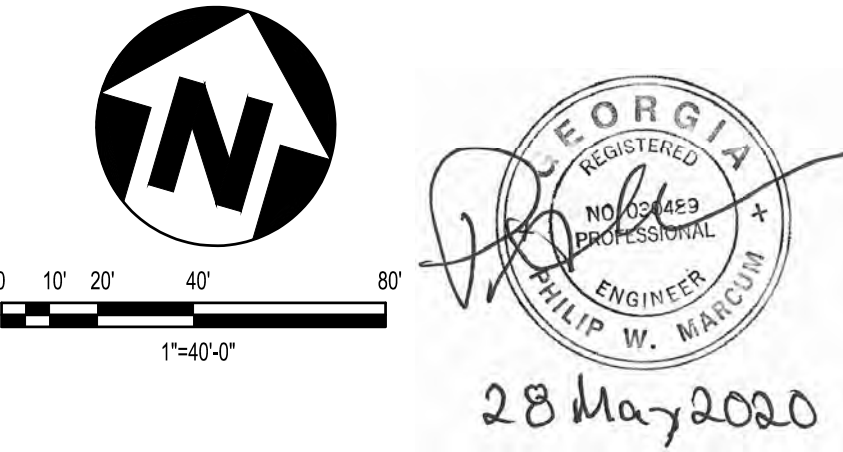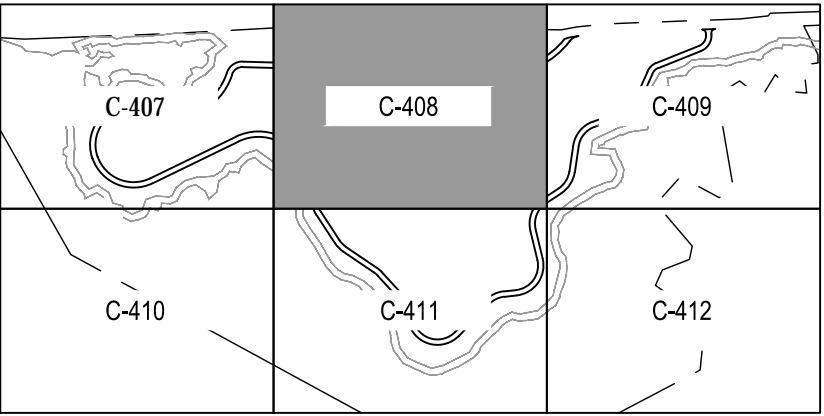

NO	DATE	REVISIONS	BY	AP.
0	20MAY20	ISSUED FOR CONSTRUCTION	LKR	PWM
A	07MAY20	FOR OWNER REVIEW	LKR	PWM

NO	DATE	REVISIONS	BY	AP.

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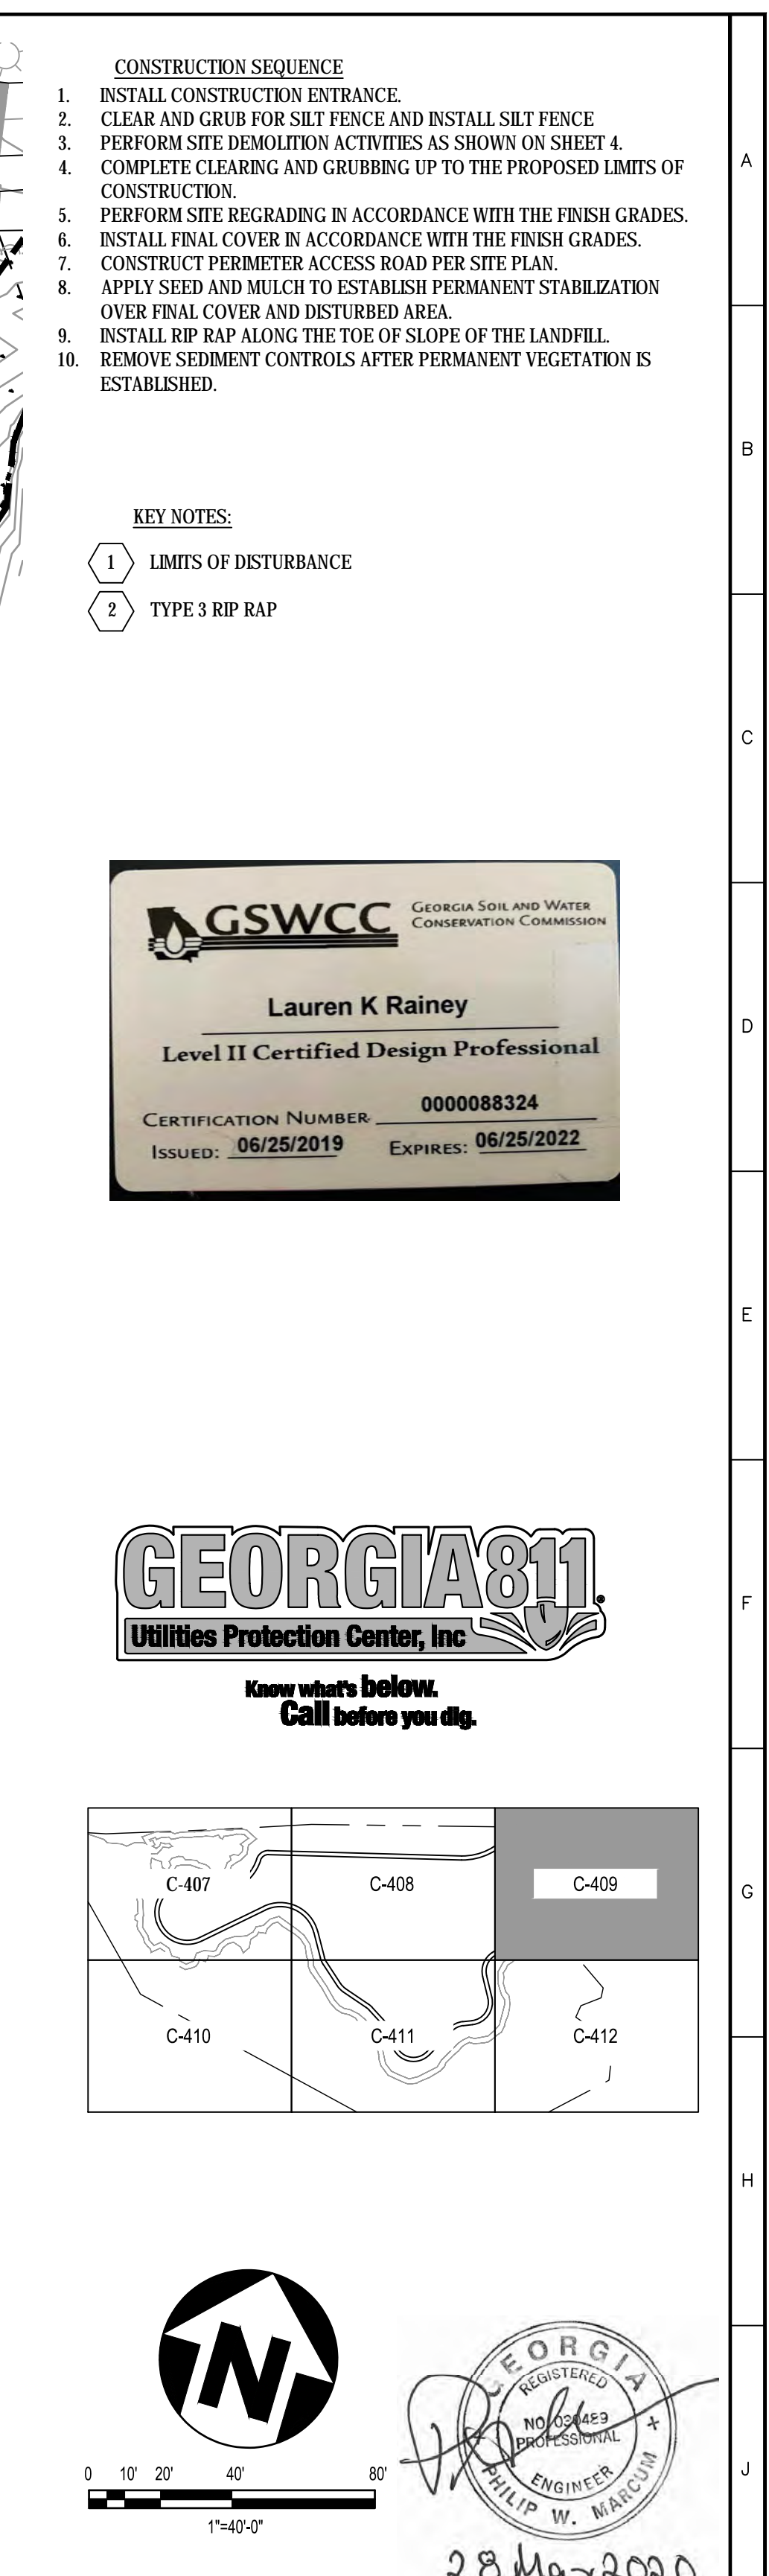
DWG. NO.	REFERENCE DRAWINGS

T STREET LANDFILL CLOSURE

GLYNN COUNTY

BRUNSWICK, GA

PHASE II INTERMEDIATE ES&PC PLAN			
ENG. LKR	JOB NO. 6123-20-1372	DATE 05/19/2020	
DR.	W. O.	DWG. NO.	REV.
CH.		6123-20-1372-C-408	----
AP. PWM			



NO		DATE		REVISIONS		BY	AP.	NO	DATE	REVISIONS		BY	AP.	NOTICE This drawing has not been published and is the sole property of T STREET LANDFILL STEERING GROUP and is lent to the borrower for their confidential use only; and in consideration of the loan of this drawing the borrower promises and agrees that it shall not be reproduced, copied, lent or otherwise disposed of directly or indirectly, nor used for any purpose other than for which it is specifically furnished.	DWG. NO.	REFERENCE DRAWINGS			T STREET LANDFILL CLOSURE			PHASE II INTERMEDIATE ES&PC PLAN															
																			GLYNN COUNTY																		
																				BRUNSWICK, GA																	
																							ENG. LKR		JOB NO. 6123-20-1372		DATE 05/19/2020										
																							DR. W. O.		DWG. NO.		REV.										
																							CH. 6123-20-1372-C-409		----												
																							AP. PWM														
0		20MAY20		ISSUED FOR CONSTRUCTION		LKR	PWM																														
A		07MAY20		FOR OWNER REVIEW		LKR	PWM																														
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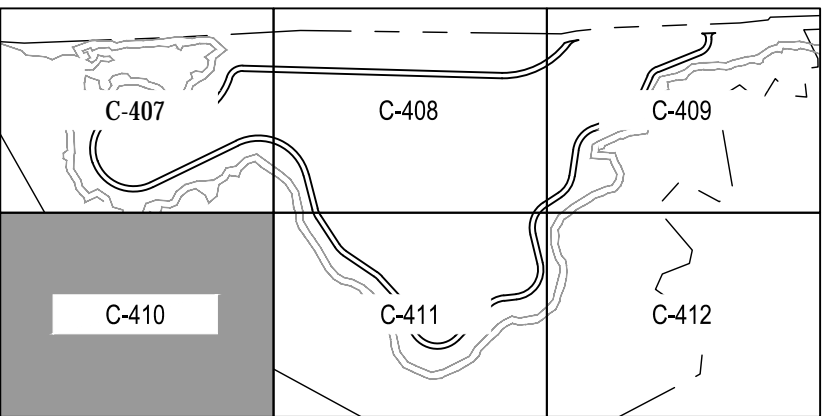


MATCHLINE C-411

1. CONSTRUCTION SEQUENCE
2. 1. INSTALL CONSTRUCTION ENTRANCE.
3. 2. CLEAR AND GRUB FOR SILT FENCE AND INSTALL SILT FENCE.
4. 3. PERFOM SITE DEMOLITION ACTIVITIES AS SHOWN ON SHEET 4.
5. 4. COMPLETE CLEARING AND GRUBBING UP TO THE PROPOSED LIMITS OF CONSTRUCTION.
6. 5. PERFORM SITE REGRADING IN ACCORDANCE WITH THE FINISH GRADES
7. 6. INSTALL FINAL COVER IN ACCORDANCE WITH THE FINISH GRADES.
8. 7. CONSTRUCT PERMETER ACCESS ROAD PER SITE PLAN.
9. 8. APPLY SEED AND MULCH TO ESTABLISH PERMANENT STABILIZATION OVER FINAL COVER AND DISTURBED AREA.
10. 9. INSTALL RIP RAP ALONG THE TOE OF SLOPE OF THE LANDFILL.
11. 10. REMOVE SEDIMENT CONTROLS AFTER PERMANENT VEGETATION IS ESTABLISHED.

KEY NOTES

- 1 LIMITS OF DISTURBANCE
 - 2 TYPE 3 RIP RAP



28 May 2020

NO	DATE	REVISIONS	BY	AP.	NO	DATE	REVISIONS	BY	AP.
▲					▲				
▲					▲				
▲					▲				
0	20MAY20	ISSUED FOR CONSTRUCTION	LKR	PWM	▲				
A	07MAY20	FOR OWNER REVIEW	LKR	PWM	▲				

NOTICE

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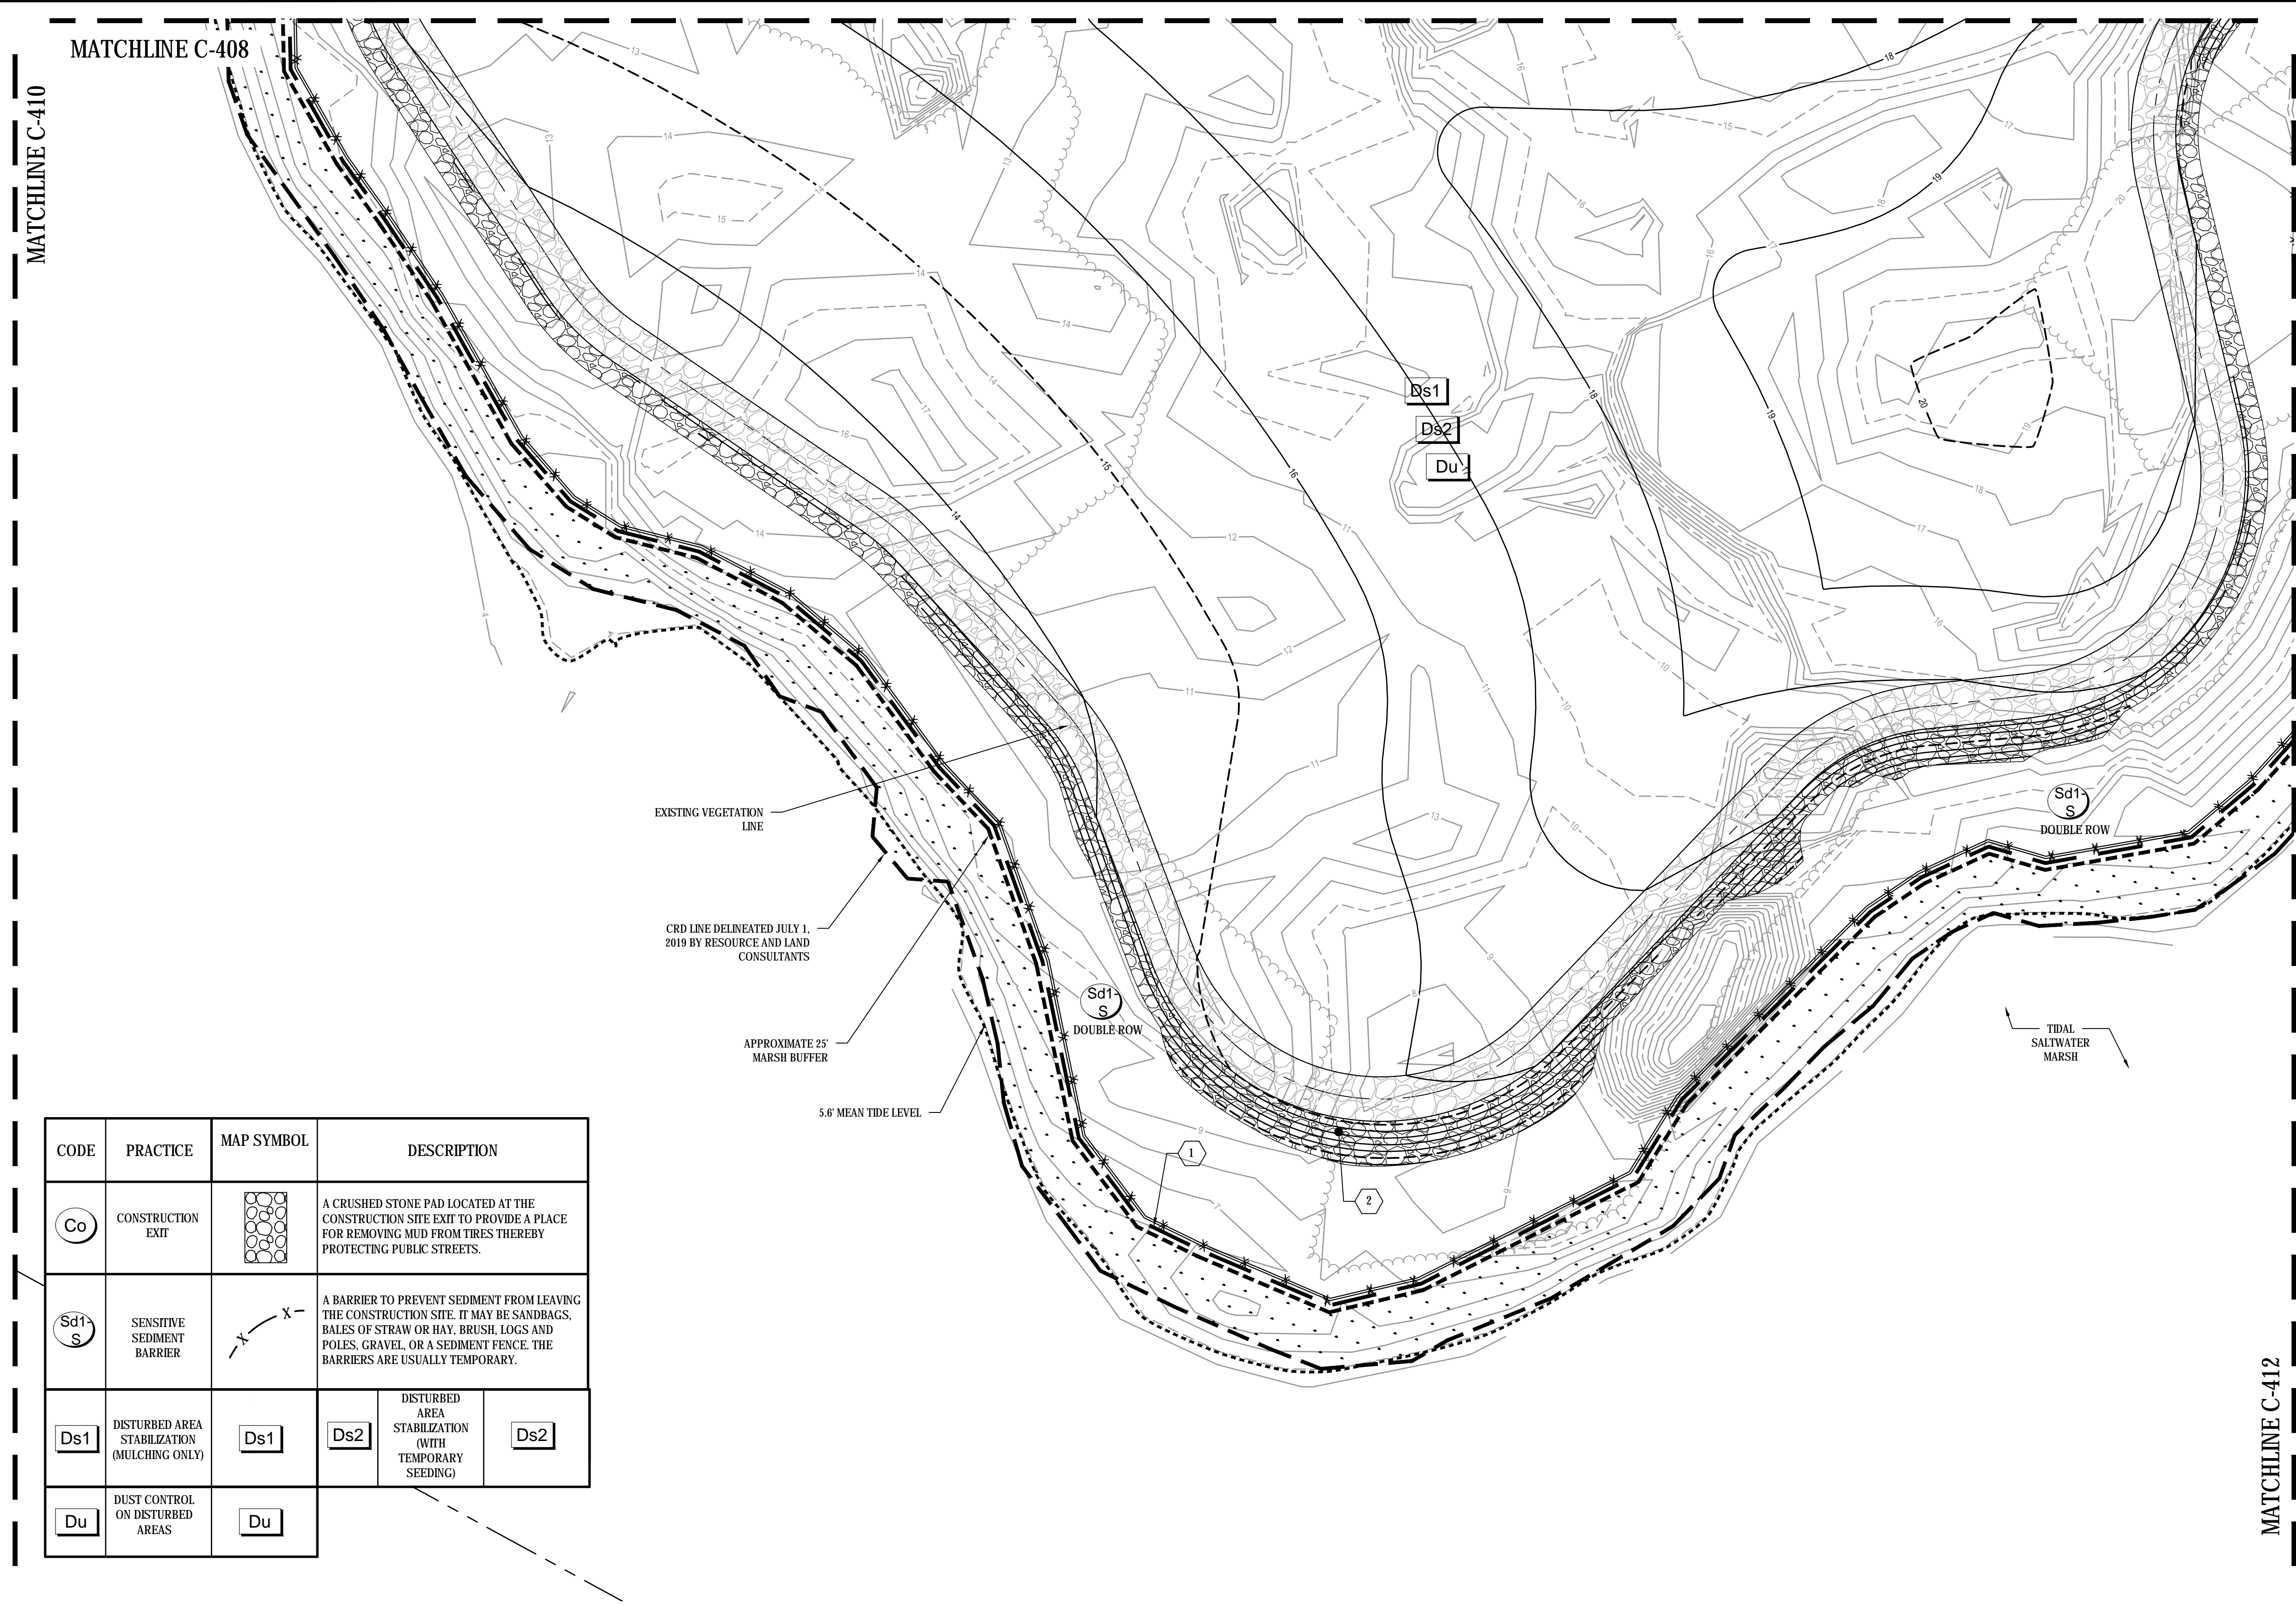
DWG. NO.	REFERENCE DRAWINGS

T STREET LANDFILL CLOSURE

GLYNN COUNTY

BRUNSWICK, GA



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ENG. LKR	JOB NO. 6123-20-1372	DATE 05/19/2020	
DR.	W. O.	DWG. NO.	REV.
CH.		6123-20-1372-C-410	----
AP. PWM			



- CONSTRUCTION SEQUENCE
1. INSTALL CONSTRUCTION ENTRANCE.
 2. CLEAR AND GRUB FOR SILT FENCE AND INSTALL SILT FENCE.
 3. PERFORM SITE DEMOLITION ACTIVITIES AS SHOWN ON SHEET 4.
 4. COMPLETE CLEARING AND GRUBBING UP TO THE PROPOSED LIMITS OF CONSTRUCTION.
 5. PERFORM SITE REGRADING IN ACCORDANCE WITH THE FINISH GRADES.
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KEY NOTES:

- 1 LIMITS OF DISTURBANCE
- 2 TYPE 3 RIP RAP

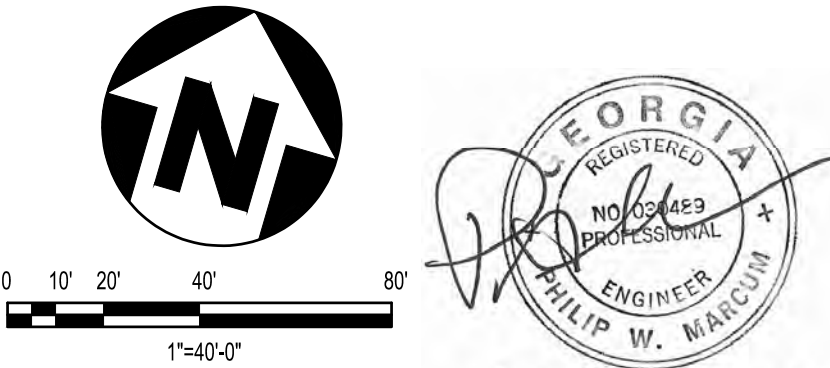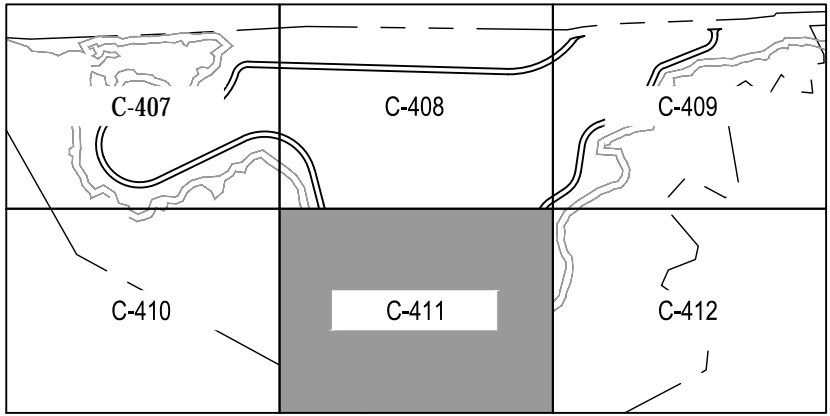

28 May 2020



NO		DATE		REVISIONS		BY	AP.	NO	DATE		REVISIONS		BY	AP.	NOTICE				DWG. NO.	REFERENCE DRAWINGS				<i>T STREET LANDFILL CLOSURE</i>				PHASE II INTERMEDIATE ES&PC PLAN									
															This drawing has not been published and is the sole property of T STREET LANDFILL STEERING GROUP and is lent to the borrower for their confidential use only; and in consideration of the loan of this drawing the borrower promises and agrees that it shall not be reproduced, copied, lent or otherwise disposed of directly or indirectly, nor used for any purpose other than for which it is specifically furnished.					GLYNN COUNTY BRUNSWICK, GA				ENG. LKR		JOB NO. 6123-20-1372		DATE 05/19/2020		REV. ----							
													DR.						W. O.					DWG. NO.													
													CH.											6123-20-1372-C-411													
0		20MAY20		ISSUED FOR CONSTRUCTION		LKR	PWM																														
A		07MAY20		FOR OWNER REVIEW		LKR	PWM																														
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
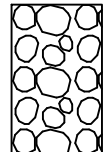
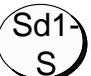
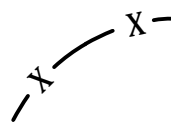
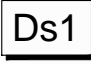
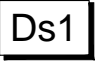
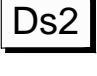
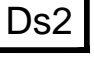
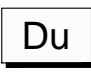
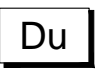
MATCHLINE C-409

1. CONSTRUCTION SEQUENCE
2. 1. INSTALL CONSTRUCTION ENTRANCE.
3. 2. CLEAR AND GRUB FOR SILT FENCE AND INSTALL SILT FENCE
4. 3. PERFORM SITE DEMOLITION ACTIVITIES AS SHOWN ON SHEET 4.
5. 4. COMPLETE CLEARING AND GRUBBING UP TO THE PROPOSED LIMITS OF CONSTRUCTION.
6. 5. PERFORM SITE REGRADING IN ACCORDANCE WITH THE FINISH GRADES.
7. 6. INSTALL FINAL COVER IN ACCORDANCE WITH THE FINISH GRADES.
8. 7. CONSTRUCT PERMETER ACCESS ROAD PER SITE PLAN.
9. 8. APPLY SEED AND MULCH TO ESTABLISH PERMANENT STABILIZATION OVER FINAL COVER AND DISTURBED AREA.
10. 9. INSTALL RIP RAP ALONG THE TOE OF SLOPE OF THE LANDFILL.
11. 10. REMOVE SEDIMENT CONTROLS AFTER PERMANENT VEGETATION IS ESTABLISHED.


KEY NOTES:

- 1 LIMITS OF DISTURBANCE
- 2 TYPE 3 RIP RAP

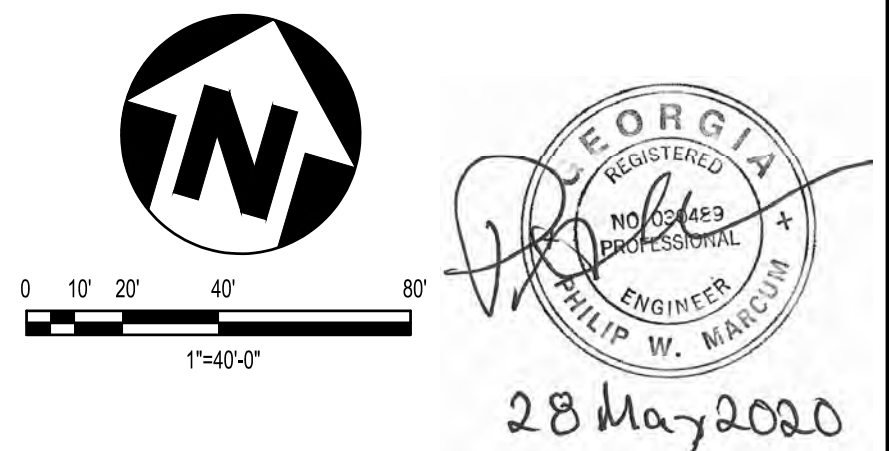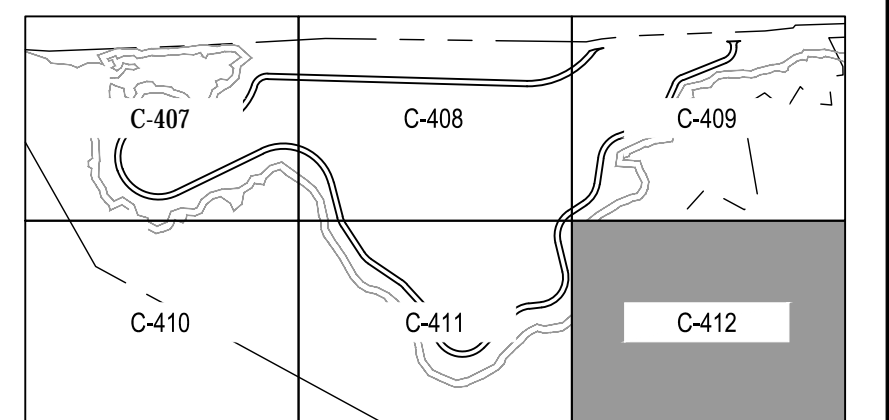

CODE	PRACTICE	MAP SYMBOL	DESCRIPTION
	CONSTRUCTION EXIT		A CRUSHED STONE PAD LOCATED AT THE CONSTRUCTION SITE EXIT TO PROVIDE A PLACE FOR REMOVING MUD FROM TIRES THEREBY PROTECTING PUBLIC STREETS.
	SENSITIVE SEDIMENT BARRIER		A BARRIER TO PREVENT SEDIMENT FROM LEAVING THE CONSTRUCTION SITE. IT MAY BE SANDBAGS, BALES OF STRAW OR HAY, BRUSH, LOGS AND POLES, GRAVEL, OR A SEDIMENT FENCE. THE BARRIERS ARE USUALLY TEMPORARY.
	DISTURBED AREA STABILIZATION (MULCHING ONLY)		<div>  <div> DISTURBED AREA STABILIZATION (WITH TEMPORARY SEEDING) </div>  </div>
	DUST CONTROL ON DISTURBED AREAS		

NO	DATE	REVISIONS	BY	AP.	NO	DATE	REVISIONS	BY	AP.	NOTICE This drawing has not been published and is the sole property of T STREET LANDFILL STEERING GROUP and is lent to the borrower for their confidential use only; and in consideration of the loan of this drawing the borrower promises and agrees that it shall not be reproduced, copied, lent or otherwise disposed of directly or indirectly, nor used for any purpose other than for which it is specifically furnished.	DWG. NO.	REFERENCE DRAWINGS	T STREET LANDFILL CLOSURE GLYNN COUNTY BRUNSWICK, GA			PHASE II INTERMEDIATE ES&PC PLAN			
0	20MAY20	ISSUED FOR CONSTRUCTION	LKR	PWM															
A	07MAY20	FOR OWNER REVIEW	LKR	PWM															
1	2	3	4	5	6	7	8	9	10	11	12	13	14	15	16	17	18	19	


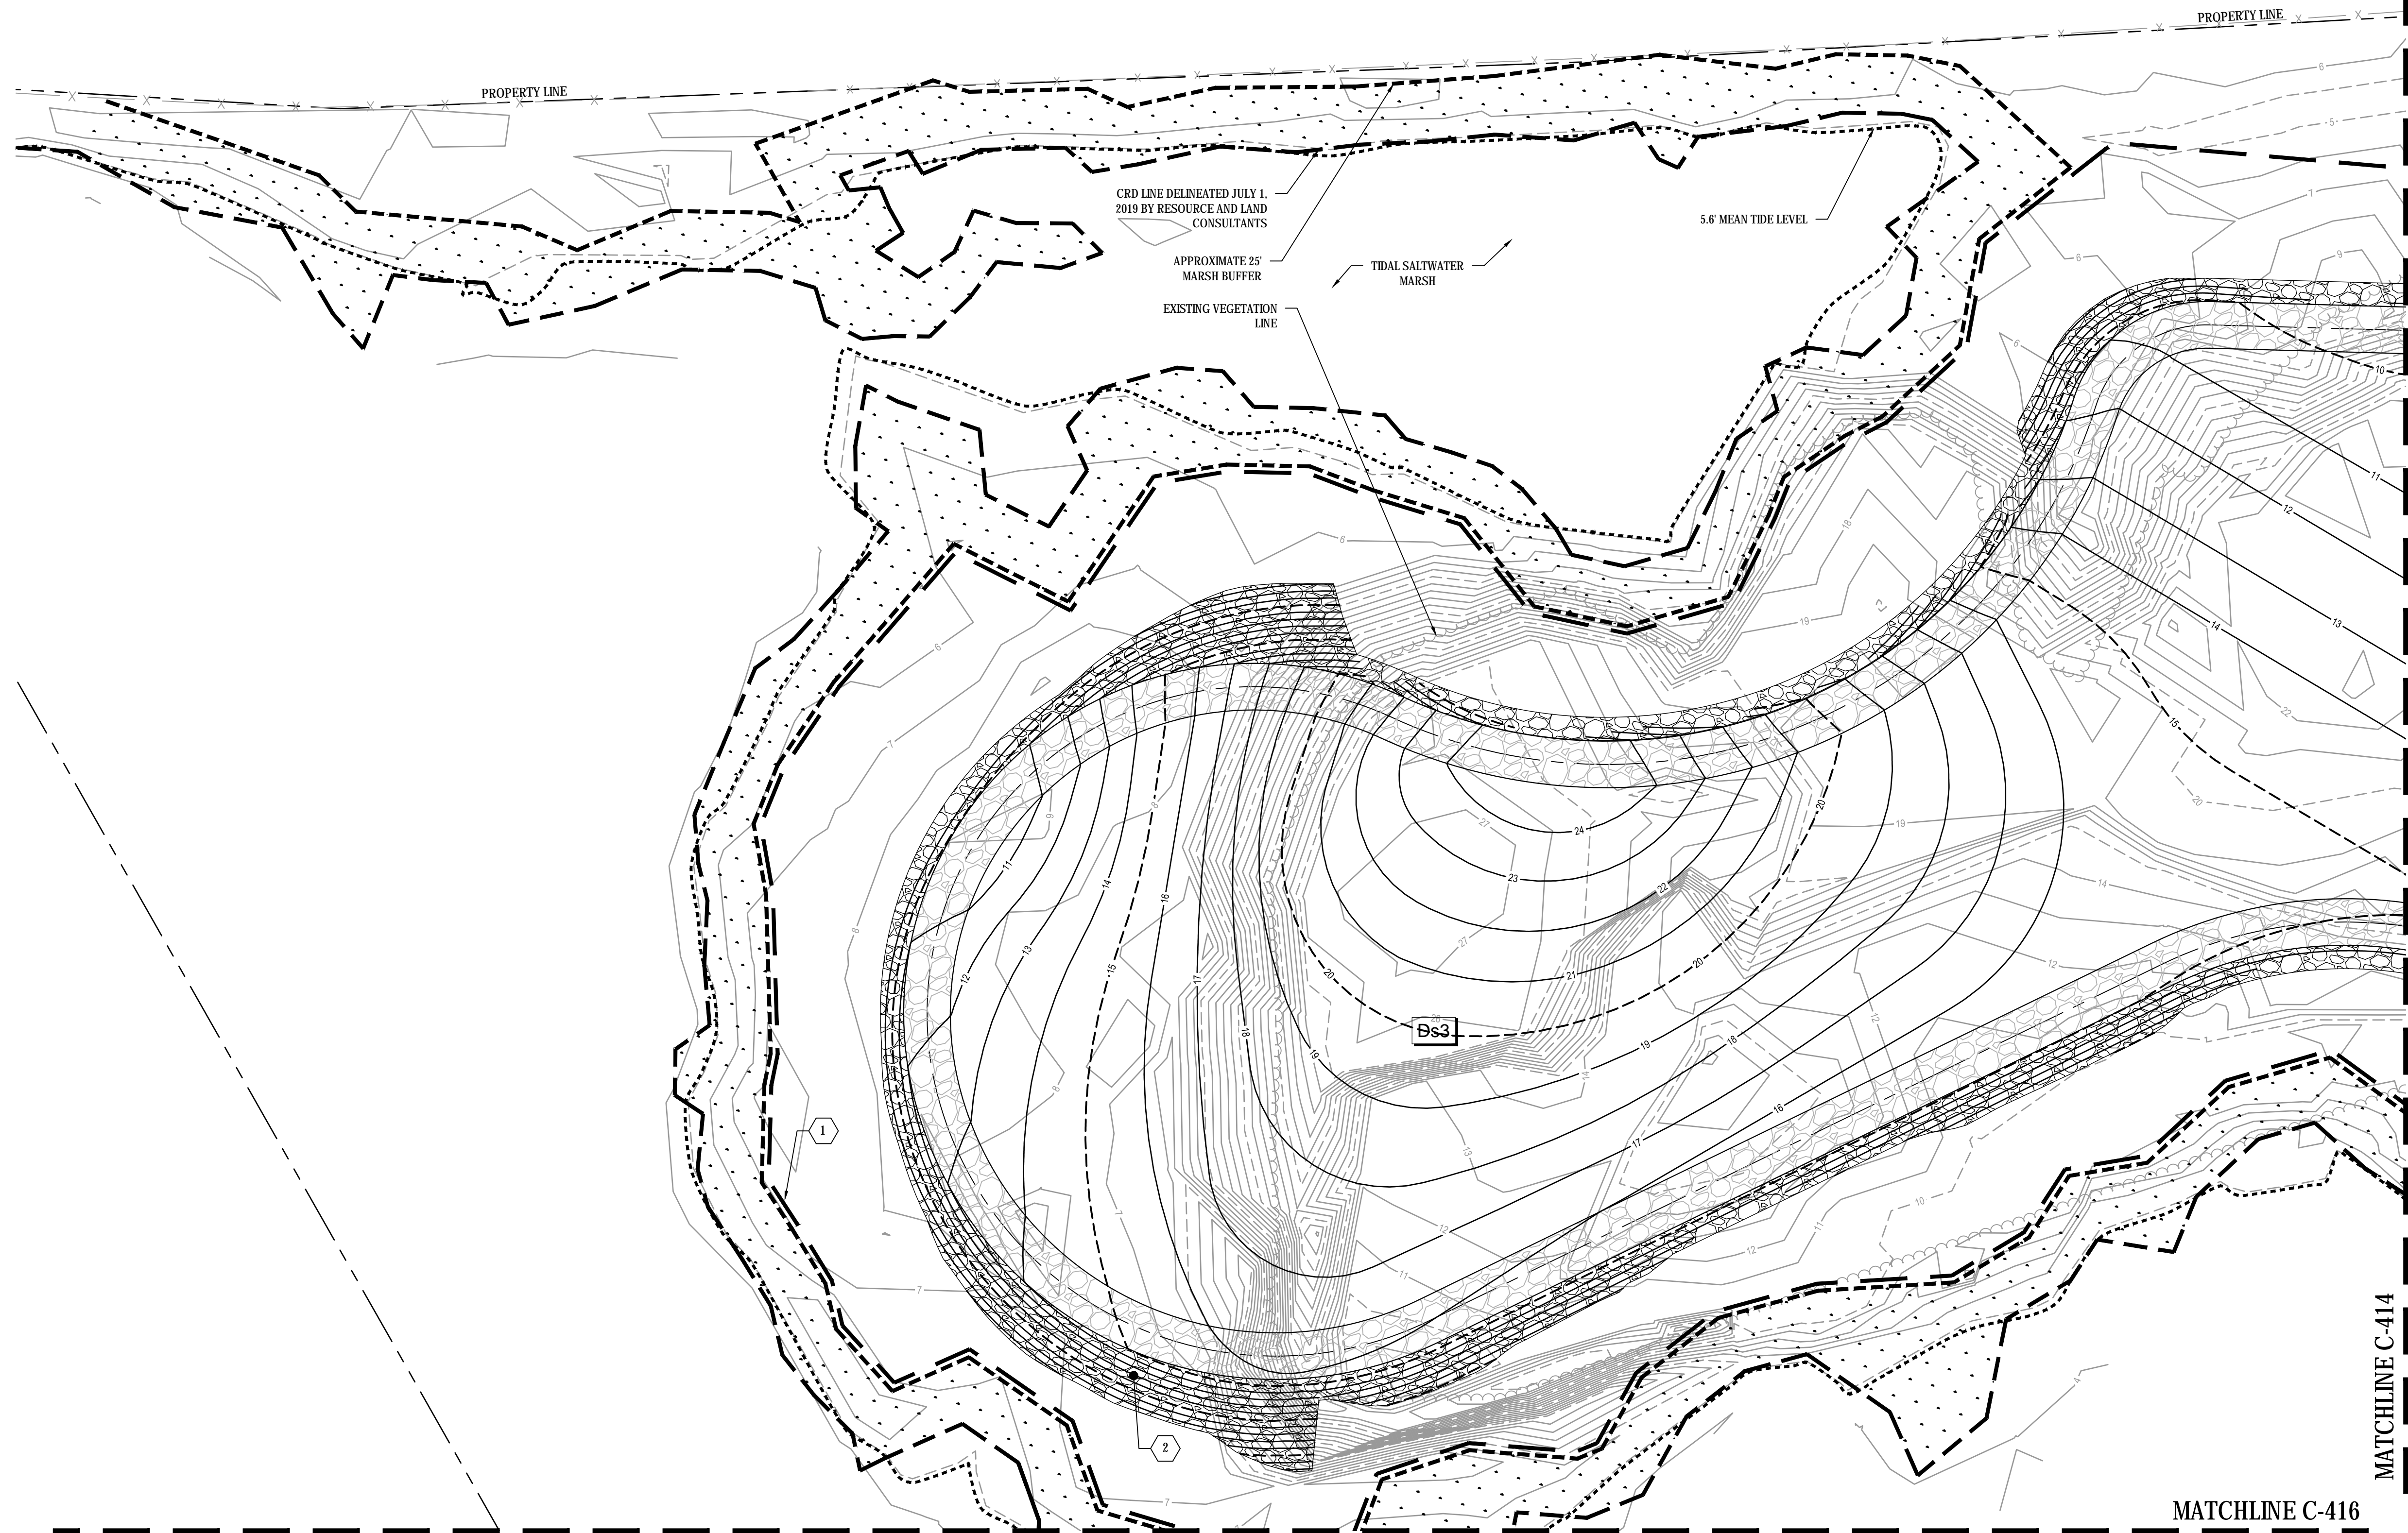


- CONSTRUCTION SEQUENCE
1. INSTALL CONSTRUCTION ENTRANCE.
 2. CLEAR AND GRUB FOR SILT FENCE AND INSTALL SILT FENCE.
 3. PERFORM SITE DEMOLITION ACTIVITIES AS SHOWN ON SHEET 4.
 4. COMPLETE CLEARING AND GRUBBING UP TO THE PROPOSED LIMITS OF CONSTRUCTION.
 5. PERFORM SITE REGRADING IN ACCORDANCE WITH THE FINISH GRADES.
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 7. CONSTRUCT PERIMETER ACCESS ROAD PER SITE PLAN.
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 10. REMOVE SEDIMENT CONTROLS AFTER PERMANENT VEGETATION IS ESTABLISHED.

- KEY NOTES:
- 1 LIMITS OF DISTURBANCE
 - 2 TYPE 3 RIP RAP



CODE	PRACTICE	MAP SYMBOL
DS3	DISTURBED AREA STABILIZATION (WITH PERMANENT VEGETATION)	DS3

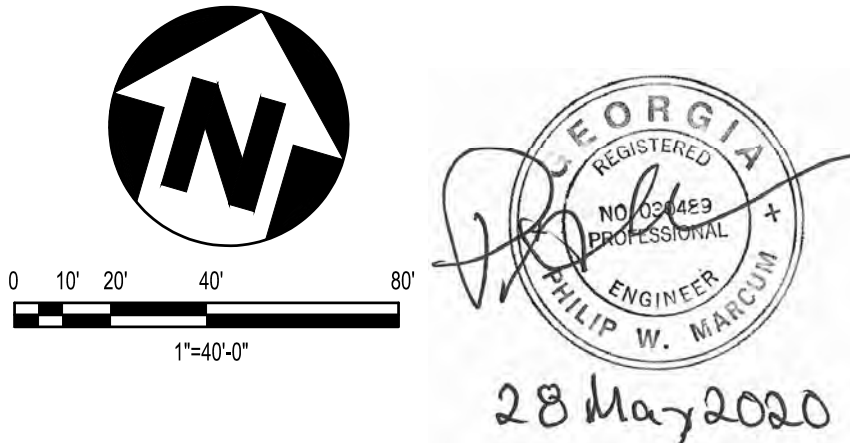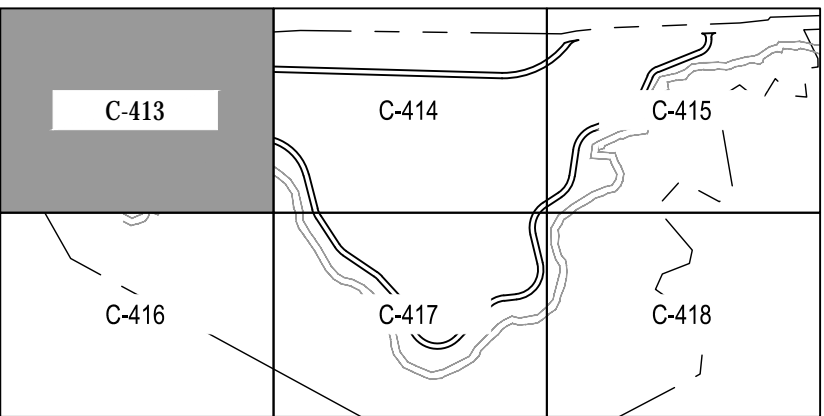


NO	DATE	REVISIONS	BY	AP.	NO	DATE	REVISIONS	BY	AP.
0	20MAY20	ISSUED FOR CONSTRUCTION	LKR	PWM					
A	07MAY20	FOR OWNER REVIEW	LKR	PWM					

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DWG. NO.	REFERENCE DRAWINGS	<i>T STREET LANDFILL CLOSURE</i> GLYNN COUNTY BRUNSWICK, GA	PHASE III FINAL ES&PC PLAN				
			ENG. LKR	JOB NO. 6123-20-1372	DATE 05/19/2020	DWG. NO. 6123-20-1372-C-413	REV. ----
			DR.	W. O.			
			CH.				
			AP.	PWM			





- CONSTRUCTION SEQUENCE
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- KEY NOTES:
- 1 LIMITS OF DISTURBANCE
 - 2 TYPE 3 RIP RAP

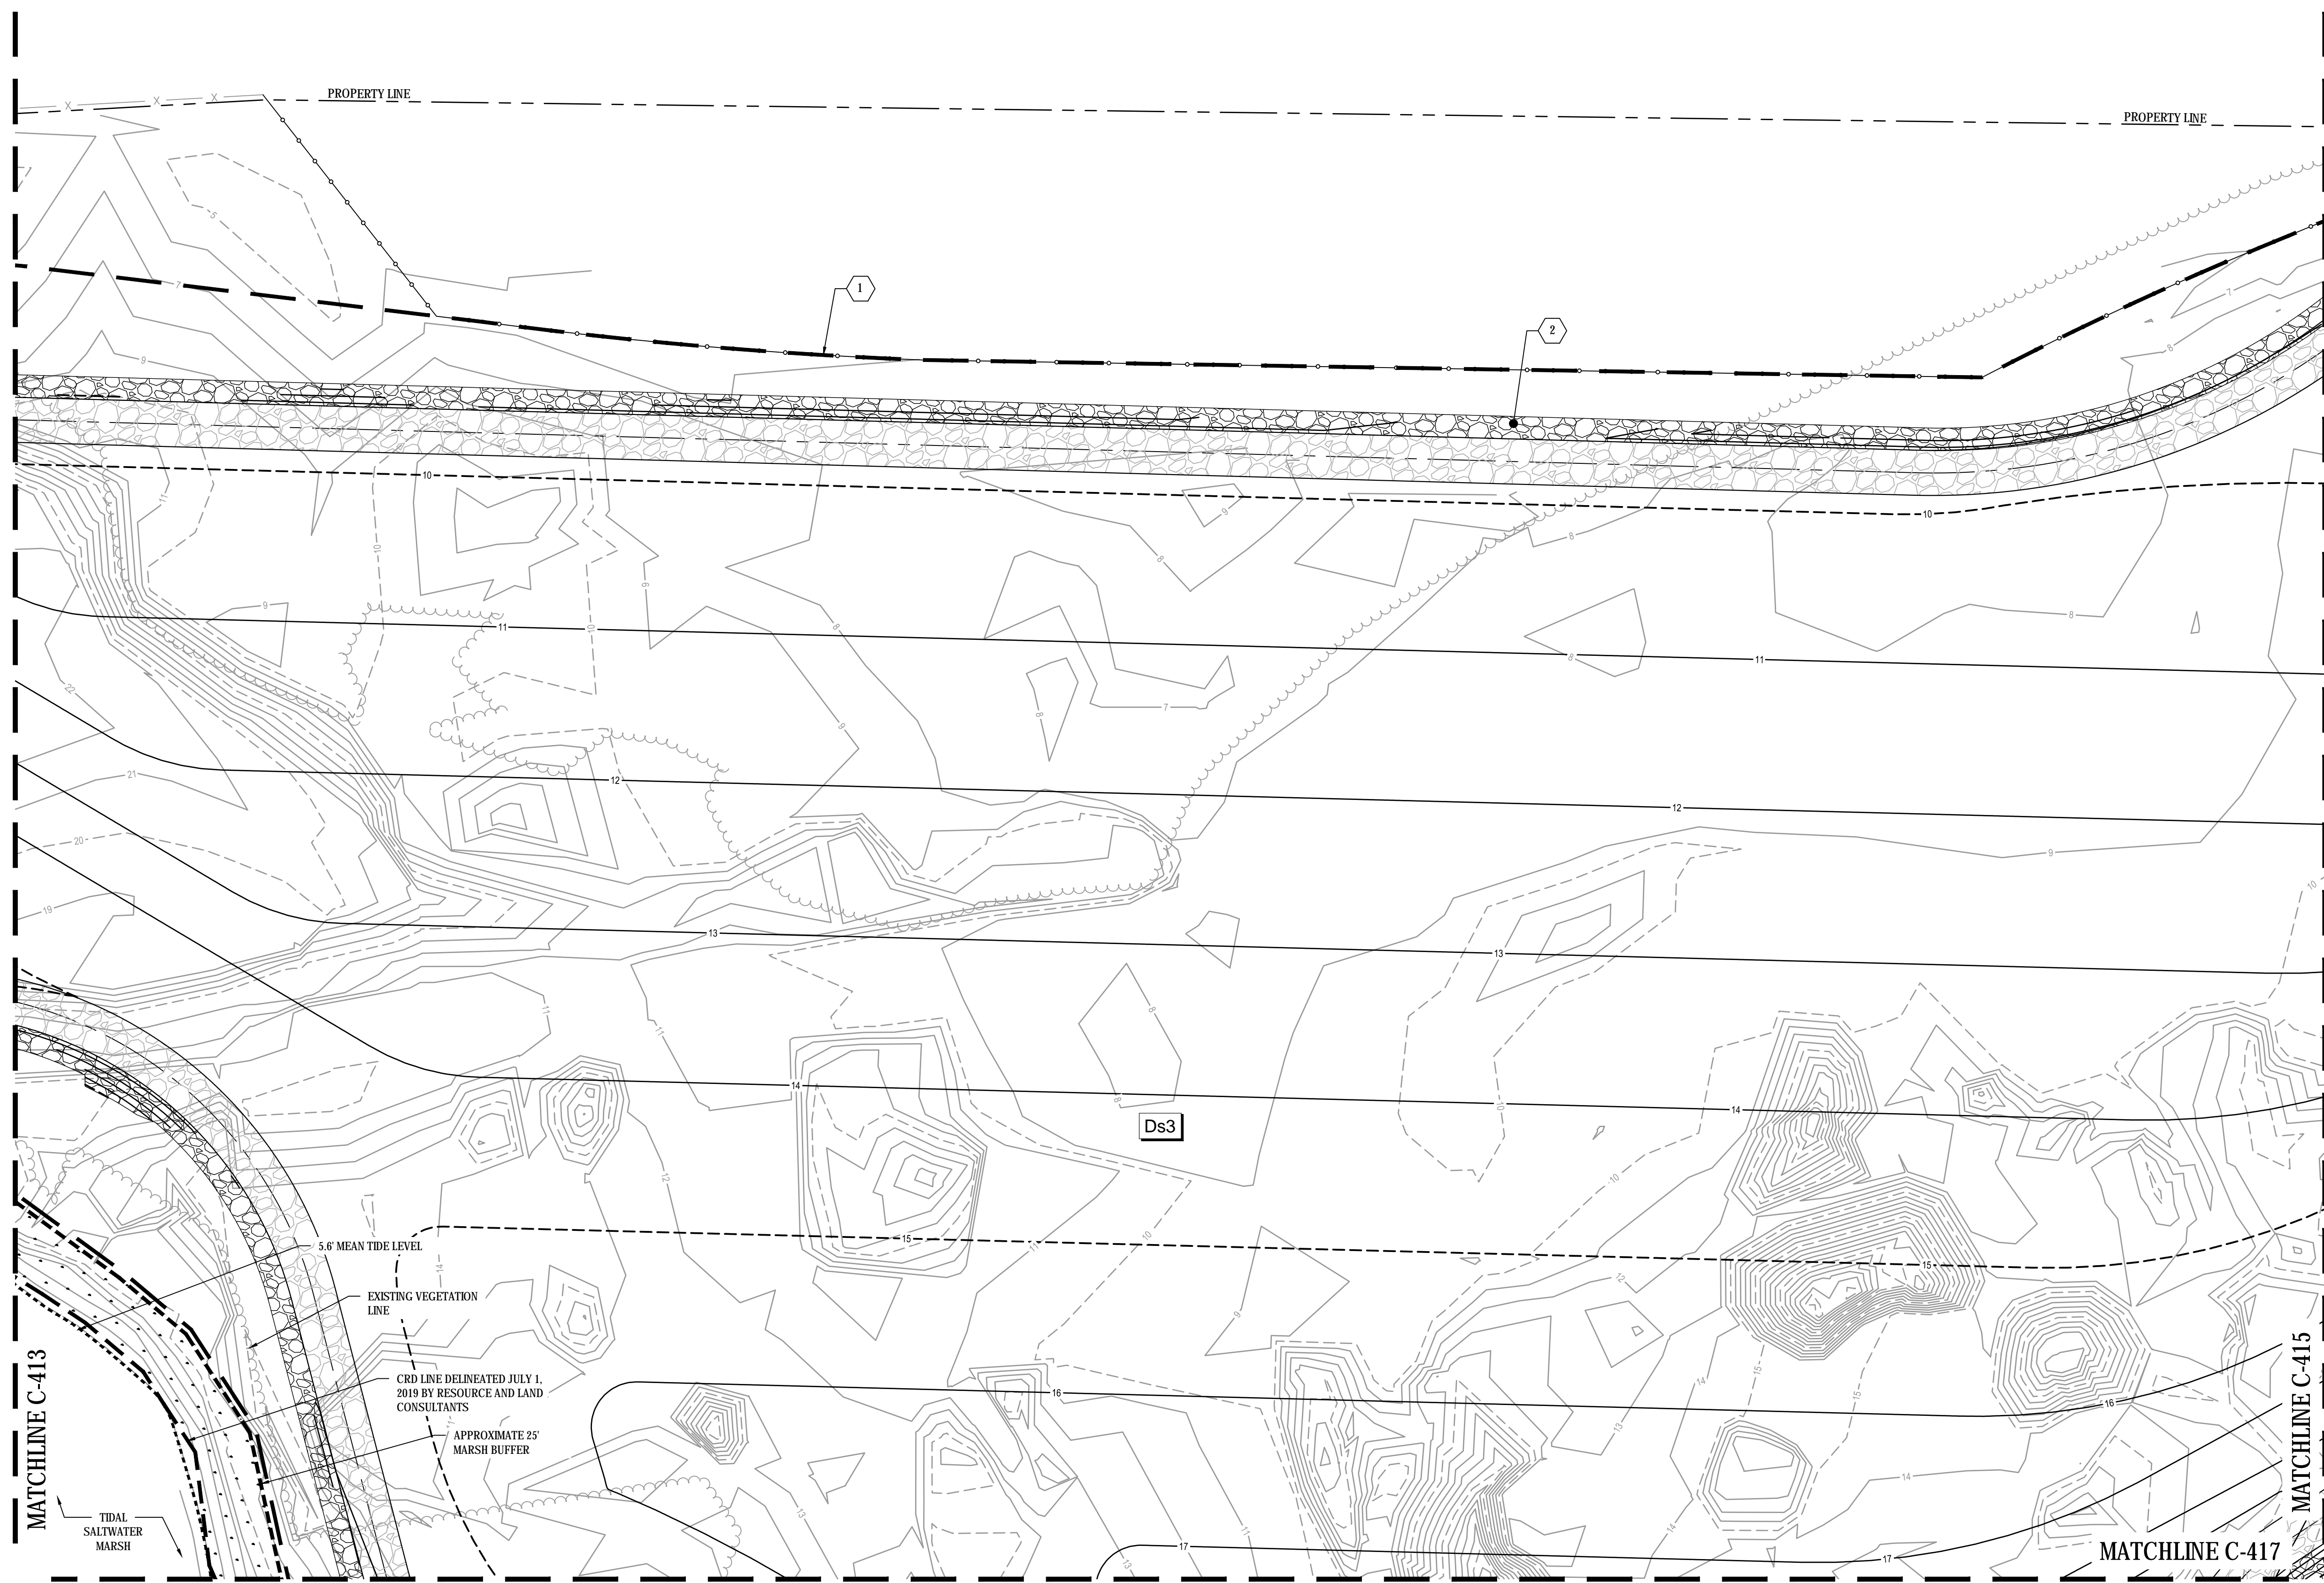

CODE	PRACTICE	MAP SYMBOL
Ds3	DISTURBED AREA STABILIZATION (WITH PERMANENT VEGETATION)	Ds3

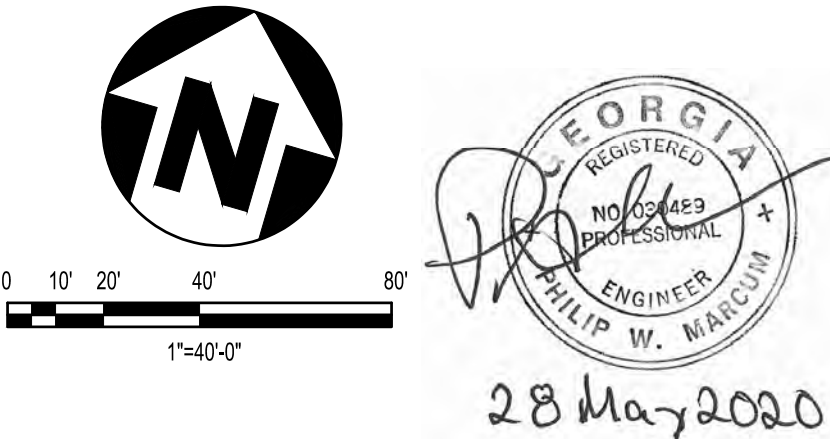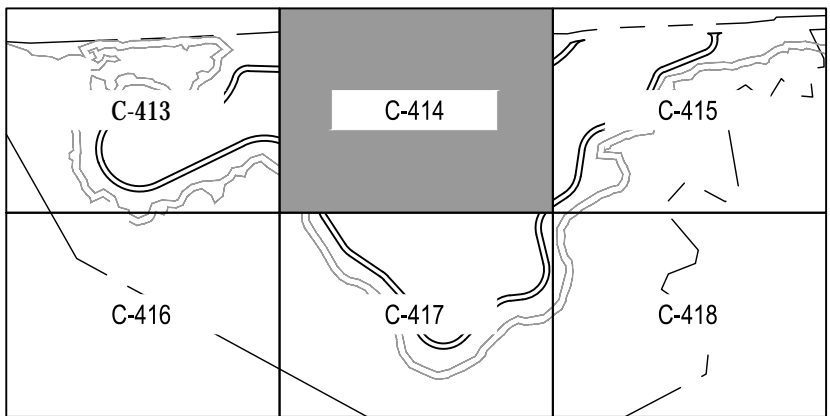

NO	DATE	REVISIONS	BY	AP.	NO	DATE	REVISIONS	BY	AP.	NO	DATE	REVISIONS	BY	AP.	NO	DATE	REVISIONS	BY	AP.
0	20MAY20	ISSUED FOR CONSTRUCTION	LKR	PWM	1					1					2				
A	07MAY20	FOR OWNER REVIEW	LKR	PWM	2					2					3				

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DWG. NO.

REFERENCE DRAWINGS


T STREET LANDFILL CLOSURE

GLYNN COUNTY

BRUNSWICK, GA

ENG. LKR	JOB NO. 6123-20-1372	DATE 05/19/2020
DR.	W. O.	DWG. NO.
CH.		6123-20-1372-C-414
AP. PWM		

REV.	----
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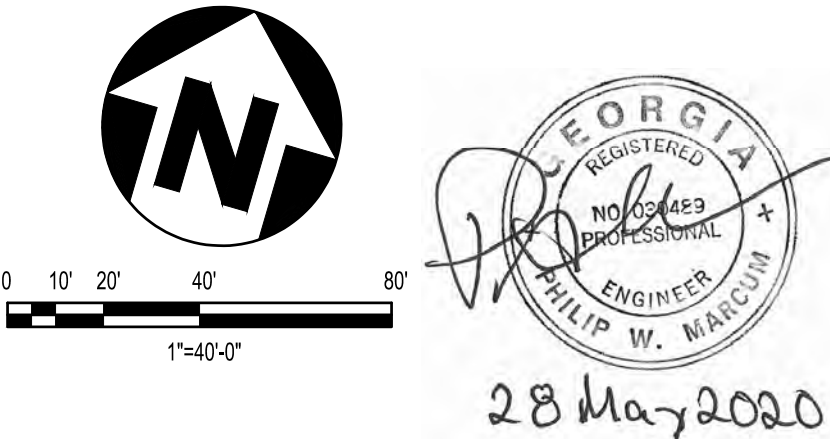
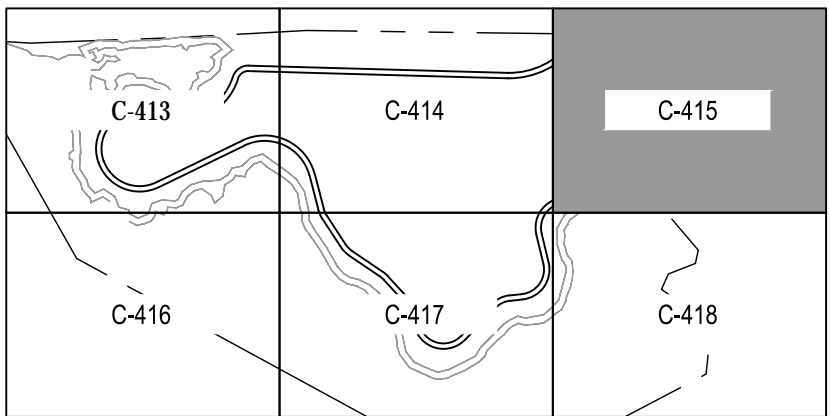


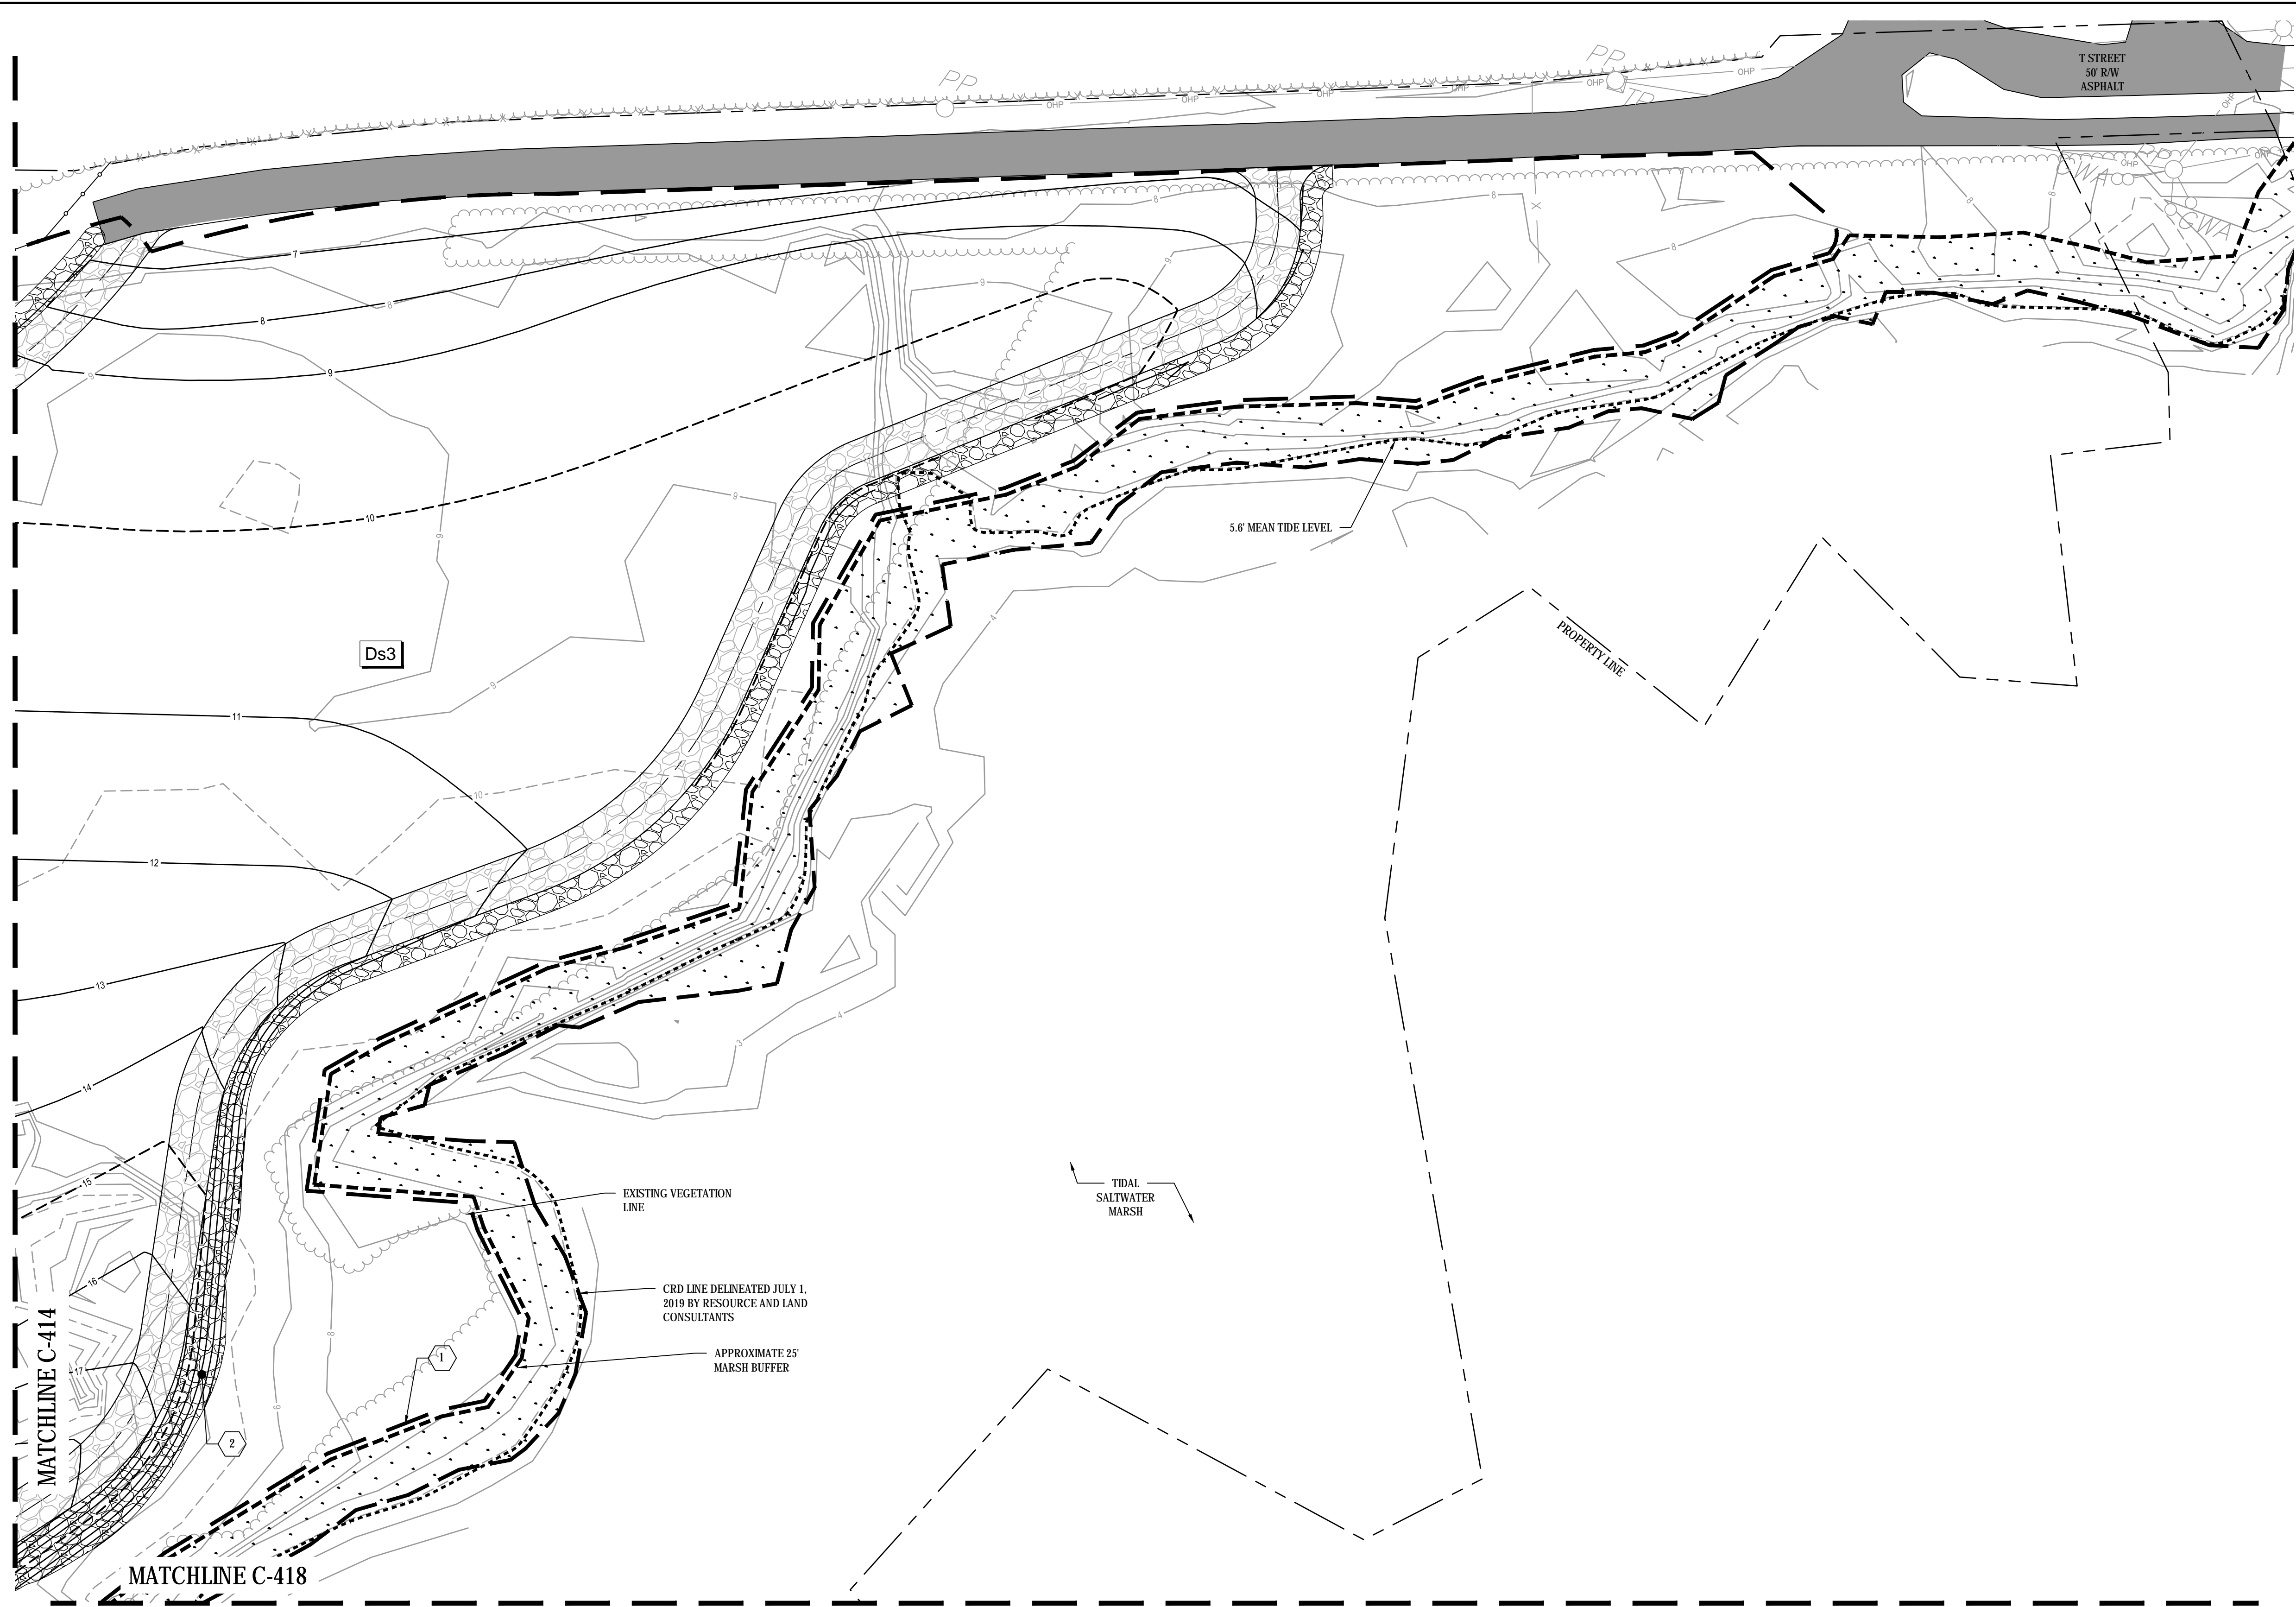- CONSTRUCTION SEQUENCE
1. INSTALL CONSTRUCTION ENTRANCE.
 2. CLEAR AND GRUB FOR SILT FENCE AND INSTALL SILT FENCE.
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- KEY NOTES:
- 1 LIMITS OF DISTURBANCE
 - 2 TYPE 3 RIP RAP



CODE	PRACTICE	MAP SYMBOL
Ds3	DISTURBED AREA STABILIZATION (WITH PERMANENT VEGETATION)	Ds3




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														This drawing has not been published and is the sole property of T STREET LANDFILL STEERING GROUP and is lent to the borrower for their confidential use only; and in consideration of the loan of this drawing the borrower promises and agrees that it shall not be reproduced, copied, lent or otherwise disposed of directly or indirectly, nor used for any purpose other than for which it is specifically furnished.						GLYNN COUNTY			ENG. LKR		JOB NO. 6123-20-1372		DATE 05/19/2020		REV. -----								
																						DR. W. O.			DWG. NO.												
																						CH. 6123-20-1372-C-415															
																						AP. PWM					16		17		18		19				
0		20MAY20		ISSUED FOR CONSTRUCTION		LKR	PWM													BRUNSWICK, GA																	
A		07MAY20		FOR OWNER REVIEW		LKR	PWM																														
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T STREET LANDFILL CLOSURE
GLYNN COUNTY
BRUNSWICK, GA

PHASE III FINAL ES&PC PLAN

ENG. LKR	JOB NO. 6123-20-1372	DATE 05/19/2020	REV.
DR.	W. O.	DWG. NO.	----
CH.		6123-20-1372-C-415	
AP. PWM			



MATCHLINE C-413

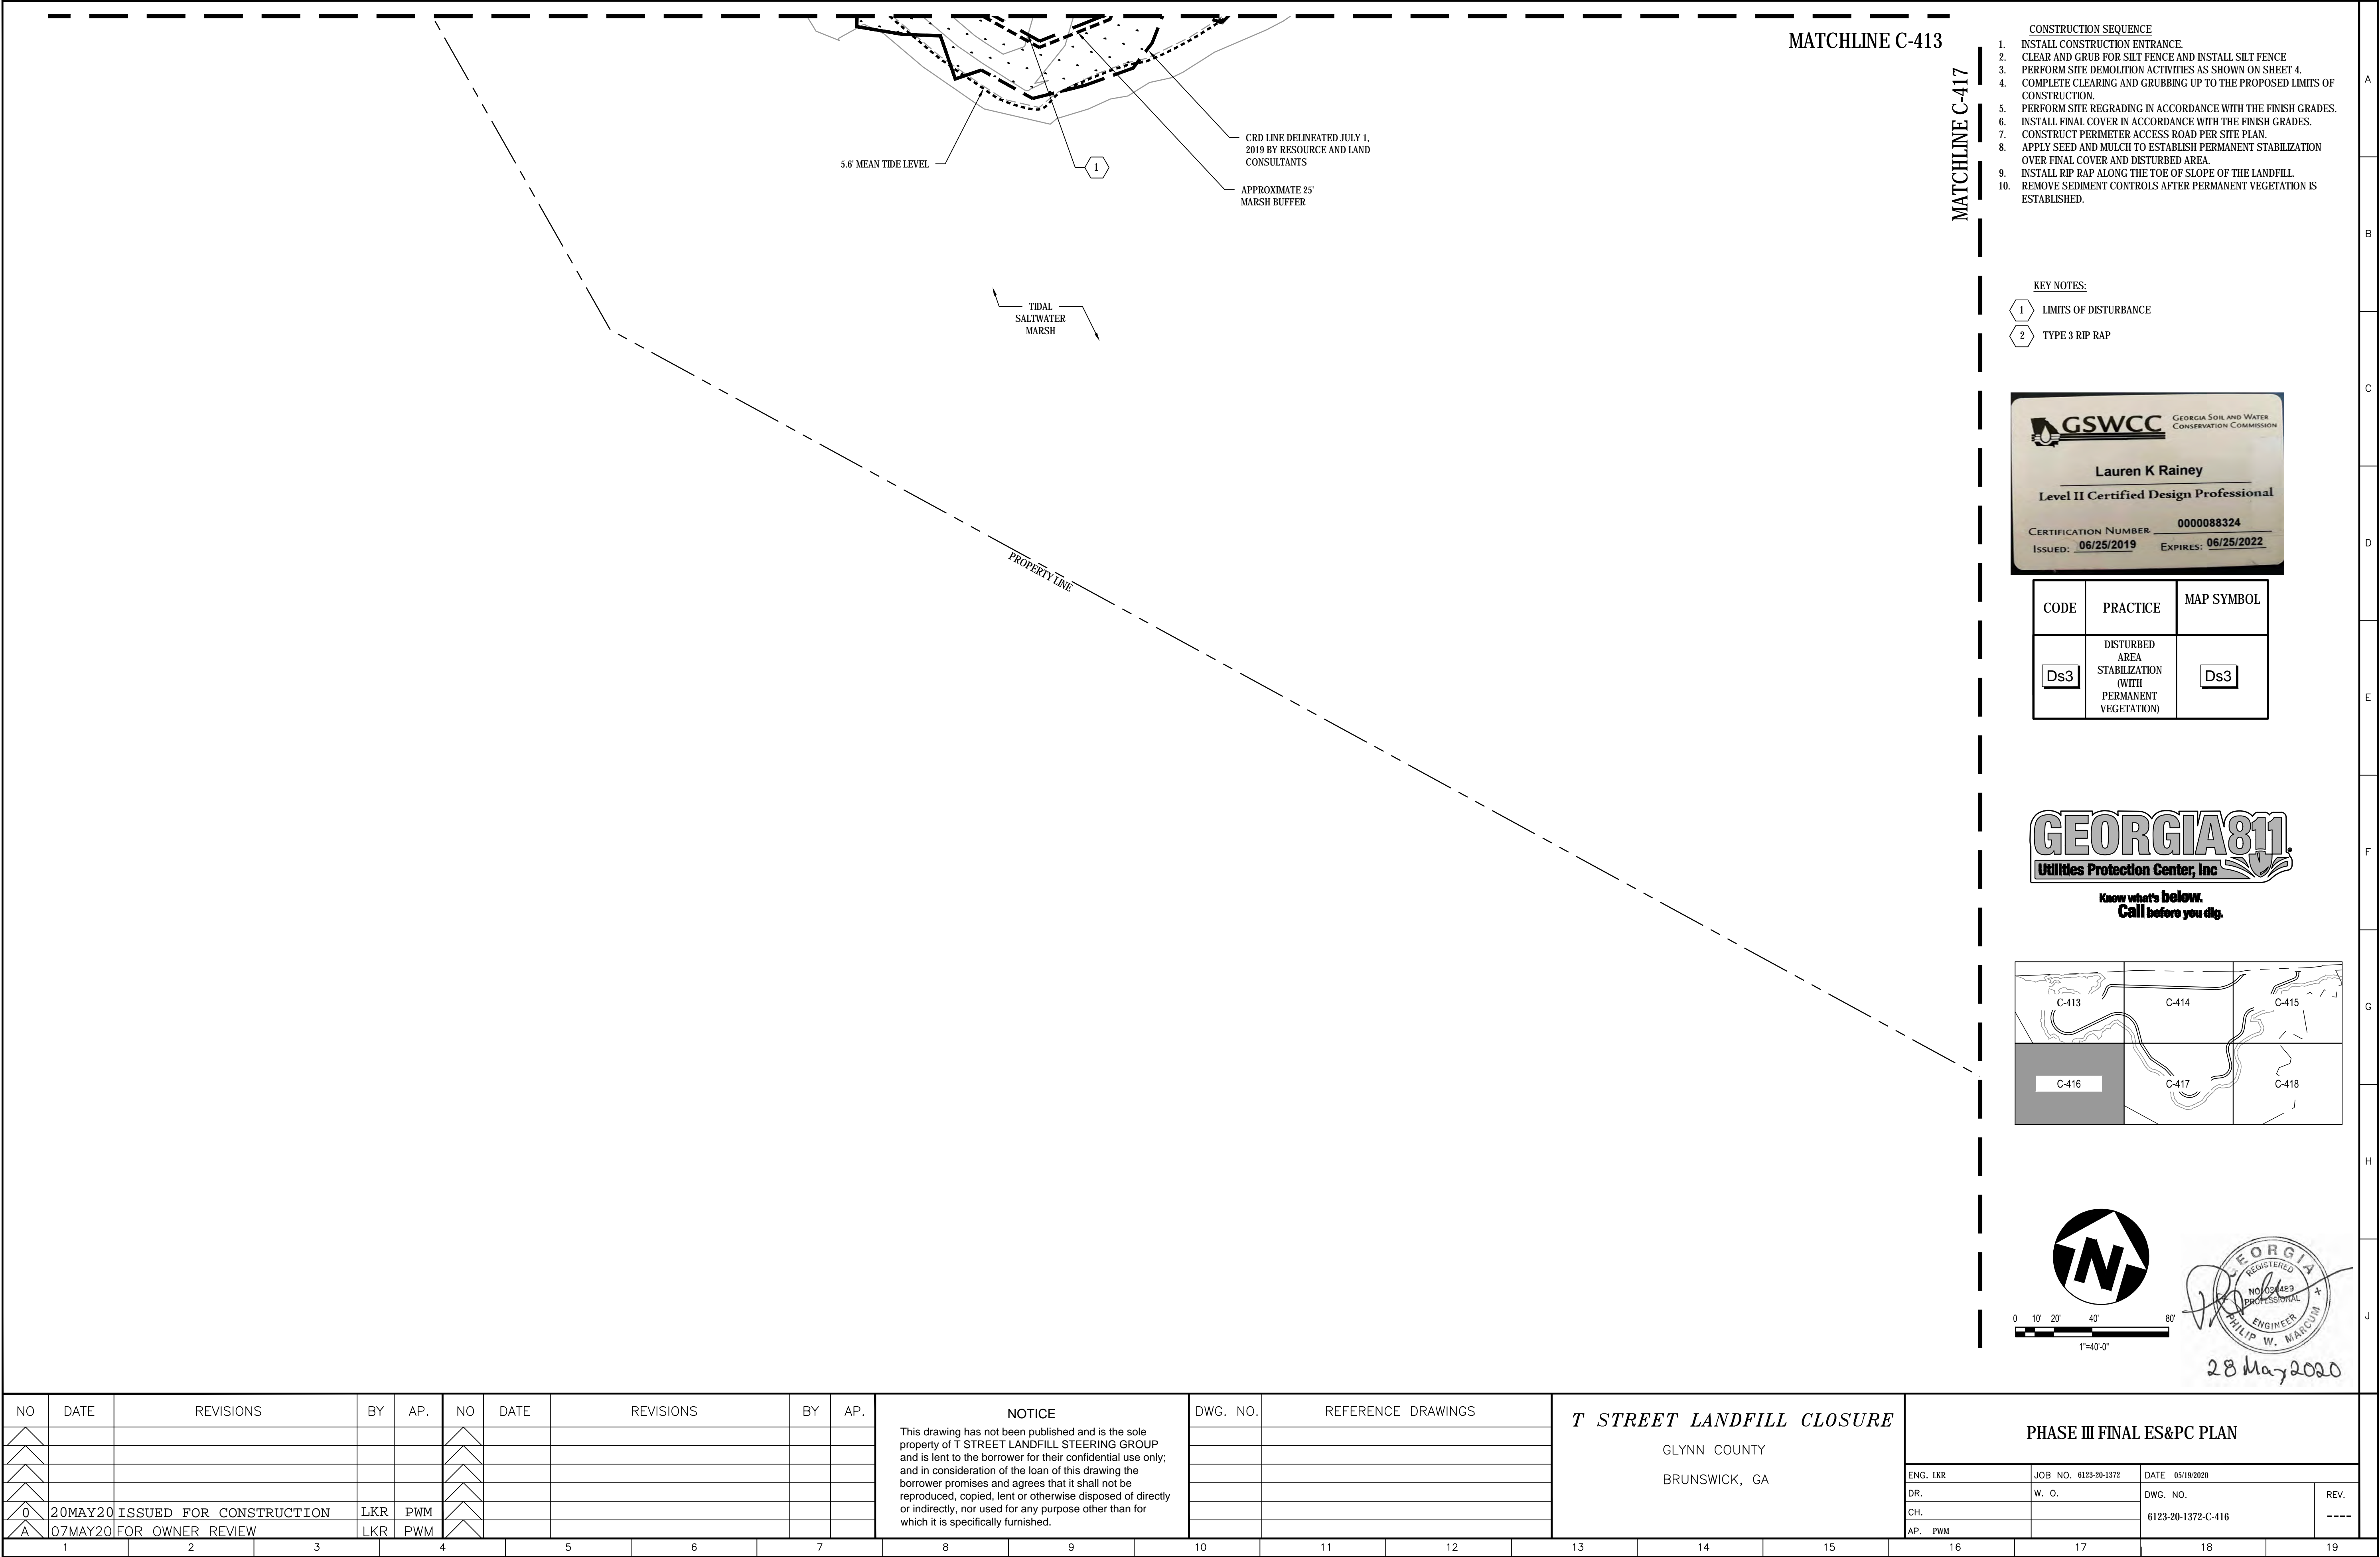MATCHLINE C-417



- CONSTRUCTION SEQUENCE
1. INSTALL CONSTRUCTION ENTRANCE.
 2. CLEAR AND GRUB FOR SILT FENCE AND INSTALL SILT FENCE.
 3. PERFORM SITE DEMOLITION ACTIVITIES AS SHOWN ON SHEET 4.
 4. COMPLETE CLEARING AND GRUBBING UP TO THE PROPOSED LIMITS OF CONSTRUCTION.
 5. PERFORM SITE REGRADING IN ACCORDANCE WITH THE FINISH GRADES.
 6. INSTALL FINAL COVER IN ACCORDANCE WITH THE FINISH GRADES.
 7. CONSTRUCT PERIMETER ACCESS ROAD PER SITE PLAN.
 8. APPLY SEED AND MULCH TO ESTABLISH PERMANENT STABILIZATION OVER FINAL COVER AND DISTURBED AREA.
 9. INSTALL RIP RAP ALONG THE TOE OF SLOPE OF THE LANDFILL.
 10. REMOVE SEDIMENT CONTROLS AFTER PERMANENT VEGETATION IS ESTABLISHED.

KEY NOTES:

- 1 LIMITS OF DISTURBANCE
- 2 TYPE 3 RIP RAP



CODE	PRACTICE	MAP SYMBOL
Ds3	DISTURBED AREA STABILIZATION (WITH PERMANENT VEGETATION)	Ds3


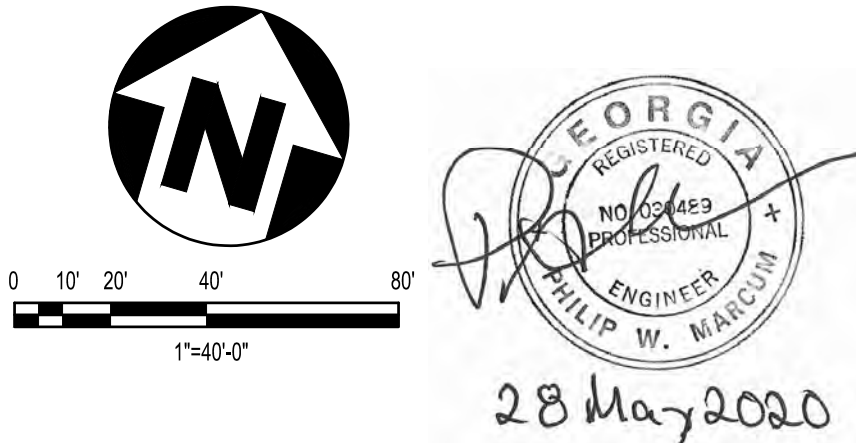
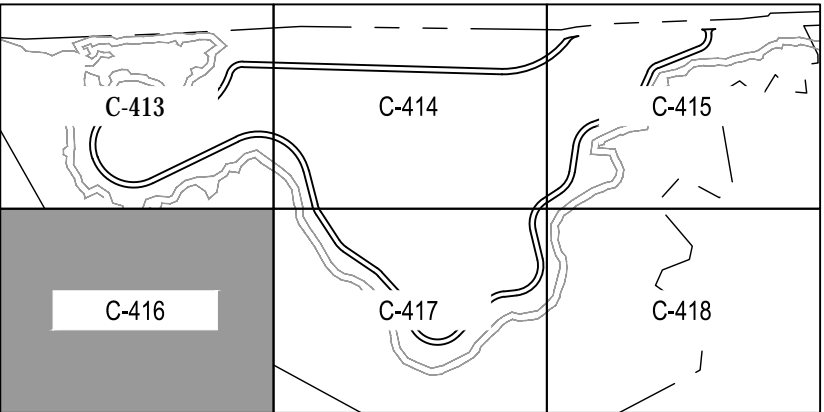


NO		DATE		REVISIONS		BY	AP.	NO	DATE	REVISIONS		BY	AP.	NOTICE This drawing has not been published and is the sole property of T STREET LANDFILL STEERING GROUP and is lent to the borrower for their confidential use only; and in consideration of the loan of this drawing the borrower promises and agrees that it shall not be reproduced, copied, lent or otherwise disposed of directly or indirectly, nor used for any purpose other than for which it is specifically furnished.	DWG. NO.	REFERENCE DRAWINGS			T STREET LANDFILL CLOSURE GLYNN COUNTY BRUNSWICK, GA			PHASE III FINAL ES&PC PLAN															
0	20MAY20	ISSUED FOR CONSTRUCTION		LKR	PWM																	ENG. LKR		JOB NO. 6123-20-1372		DATE 05/19/2020		REV. ----									
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MATCHLINE C-416

KEY NOTES:

1	LIMITS OF DISTURBANCE
2	TYPE 3 RIP RAP

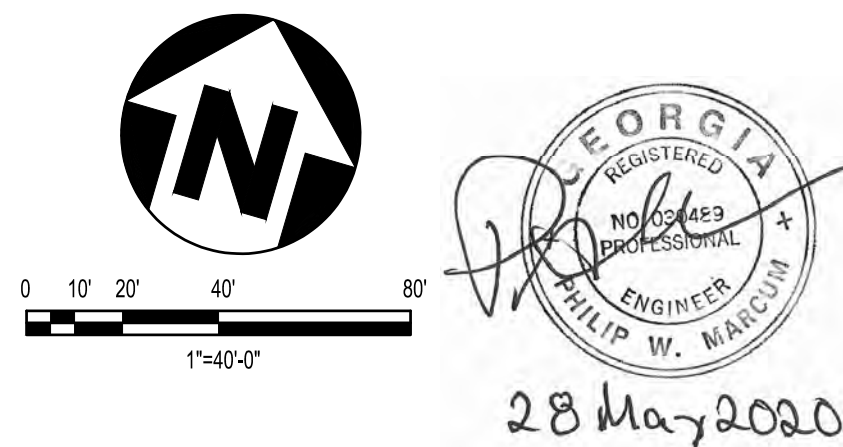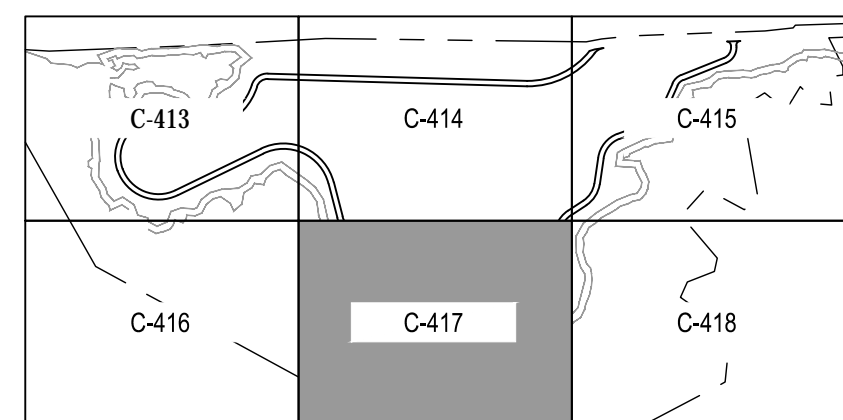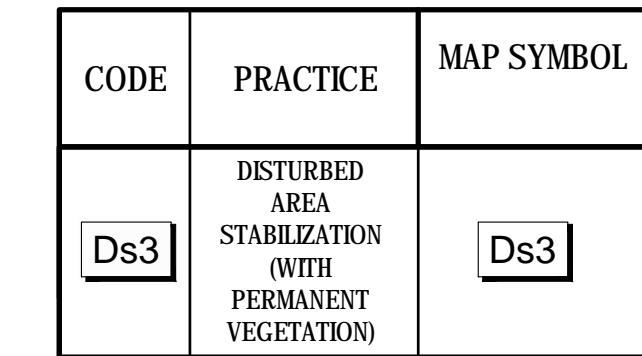


EXISTING VEGETATION
LINE

CRD LINE DELINEATED JULY 1,
2019 BY RESOURCE AND LAND
CONSULTANTS

APPROXIMATE 25'
MARSH BUFFER

— TIDAL —
SALTWATER
MARSH

NO		DATE	REVISIONS		BY	AP.	NO	DATE	REVISIONS		BY	AP.	NOTICE This drawing has not been published and is the sole property of T STREET LANDFILL STEERING GROUP and is lent to the borrower for their confidential use only; and in consideration of the loan of this drawing the borrower promises and agrees that it shall not be reproduced, copied, lent or otherwise disposed of directly or indirectly, nor used for any purpose other than for which it is specifically furnished.	DWG. NO.	REFERENCE DRAWINGS		T STREET LANDFILL CLOSURE GLYNN COUNTY BRUNSWICK, GA			PHASE III FINAL ES&PC PLAN																	
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																		CH.	6123-20-1372-C-417																		
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MATCHLINE C-415


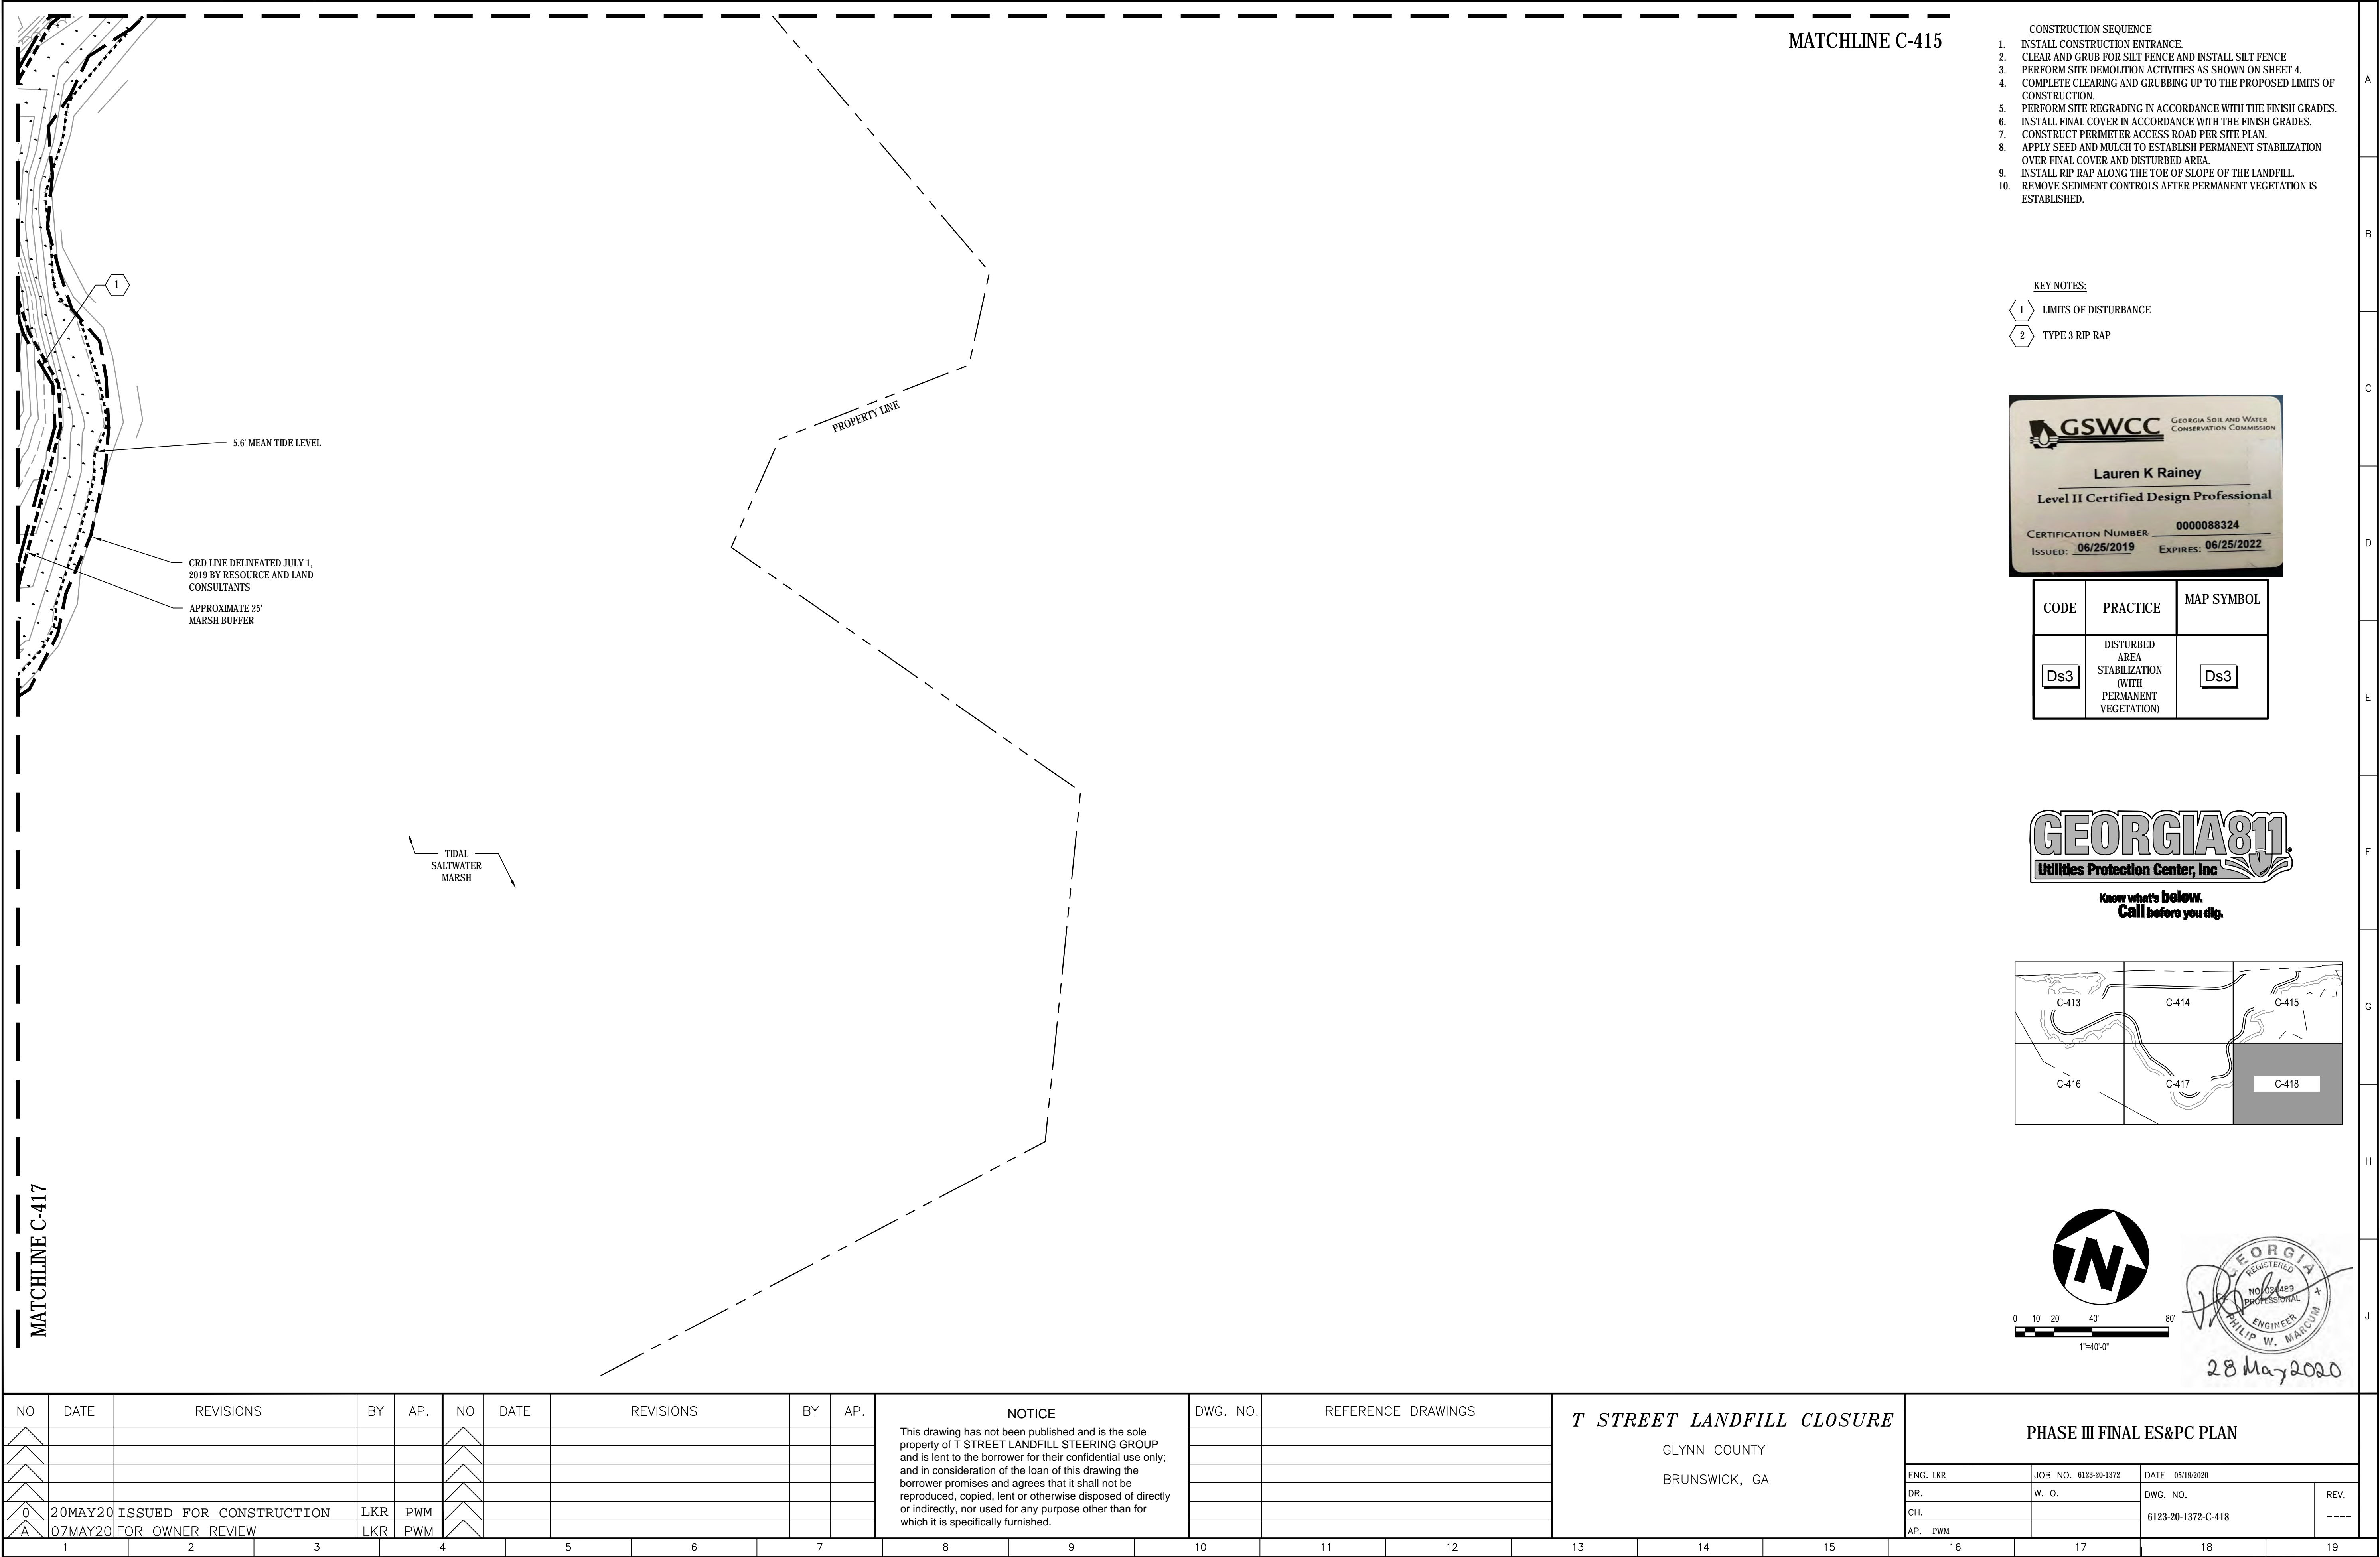
- CONSTRUCTION SEQUENCE
1. INSTALL CONSTRUCTION ENTRANCE.
 2. CLEAR AND GRUB FOR SILT FENCE AND INSTALL SILT FENCE.
 3. PERFORM SITE DEMOLITION ACTIVITIES AS SHOWN ON SHEET 4.
 4. COMPLETE CLEARING AND GRUBBING UP TO THE PROPOSED LIMITS OF CONSTRUCTION.
 5. PERFORM SITE REGRADING IN ACCORDANCE WITH THE FINISH GRADES.
 6. INSTALL FINAL COVER IN ACCORDANCE WITH THE FINISH GRADES.
 7. CONSTRUCT PERIMETER ACCESS ROAD PER SITE PLAN.
 8. APPLY SEED AND MULCH TO ESTABLISH PERMANENT STABILIZATION OVER FINAL COVER AND DISTURBED AREA.
 9. INSTALL RIP RAP ALONG THE TOE OF SLOPE OF THE LANDFILL.
 10. REMOVE SEDIMENT CONTROLS AFTER PERMANENT VEGETATION IS ESTABLISHED.

KEY NOTES:


- 1 LIMITS OF DISTURBANCE
- 2 TYPE 3 RIP RAP



CODE	PRACTICE	MAP SYMBOL
Ds3	DISTURBED AREA STABILIZATION (WITH PERMANENT VEGETATION)	Ds3

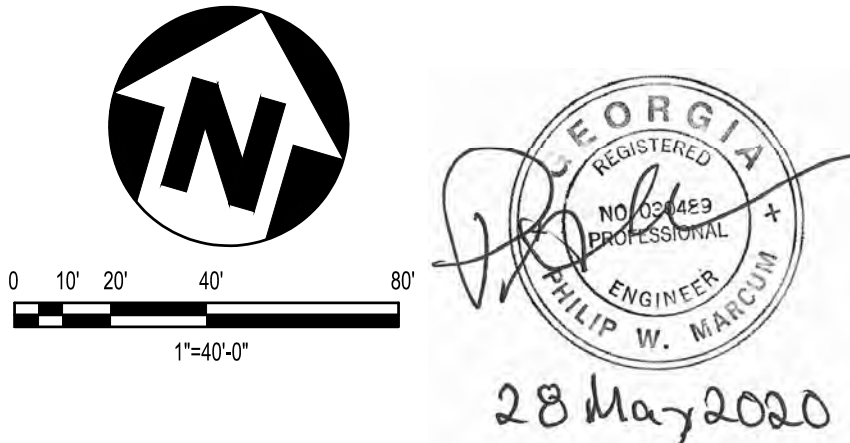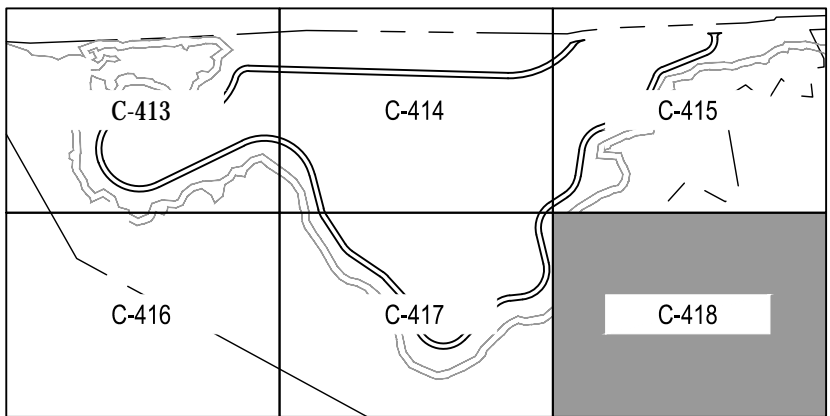


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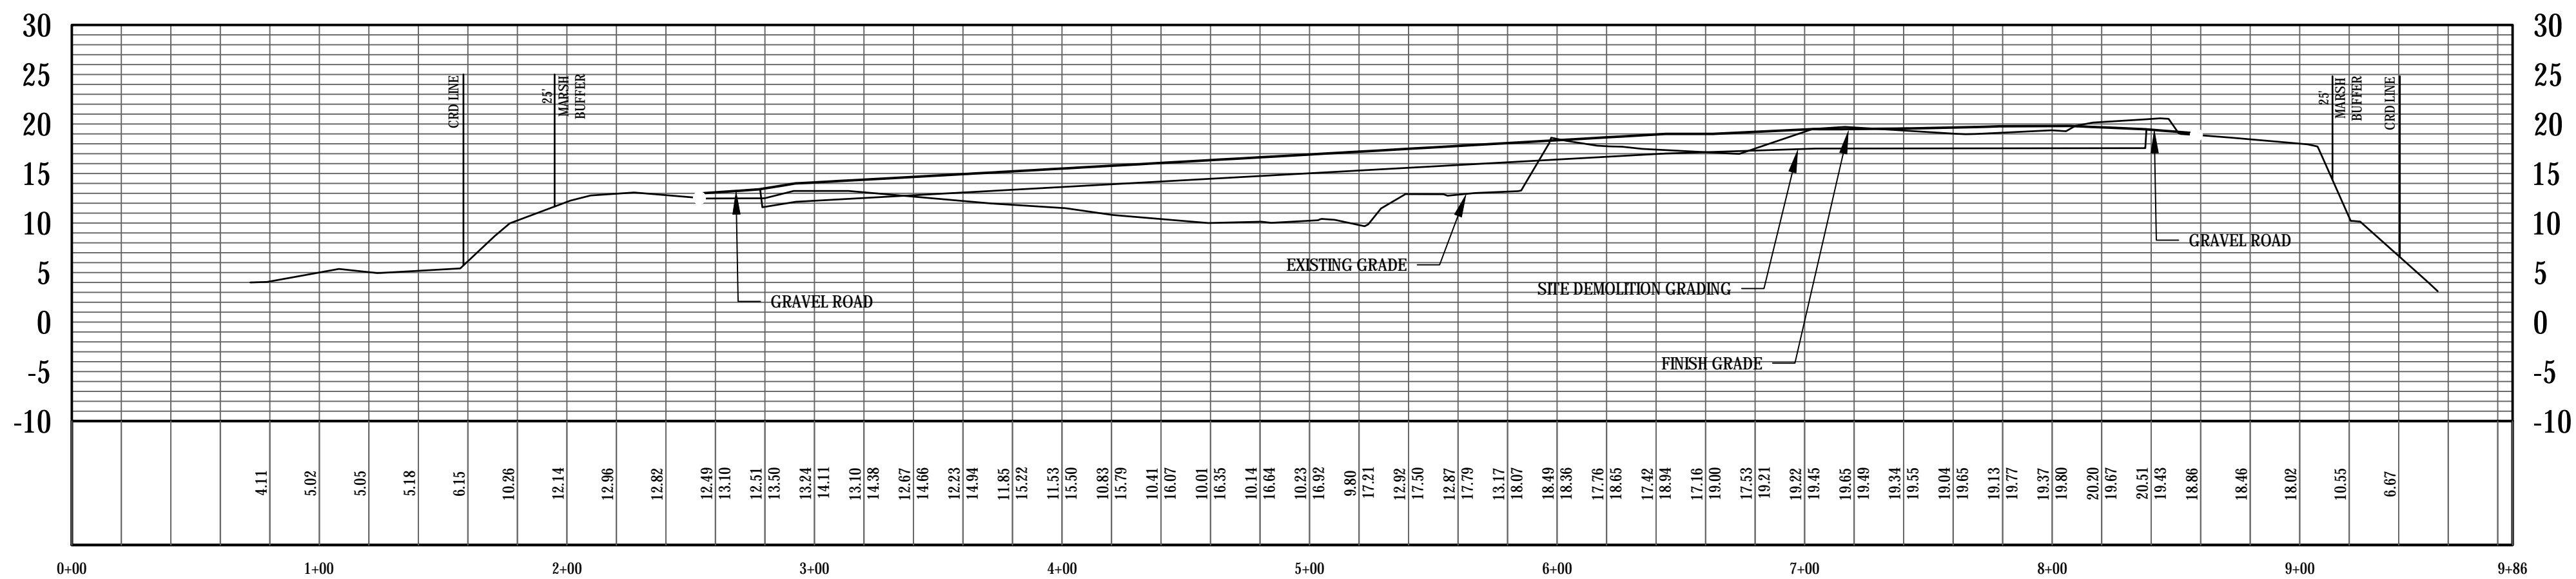
1 FINAL COVER GRADING DETAIL

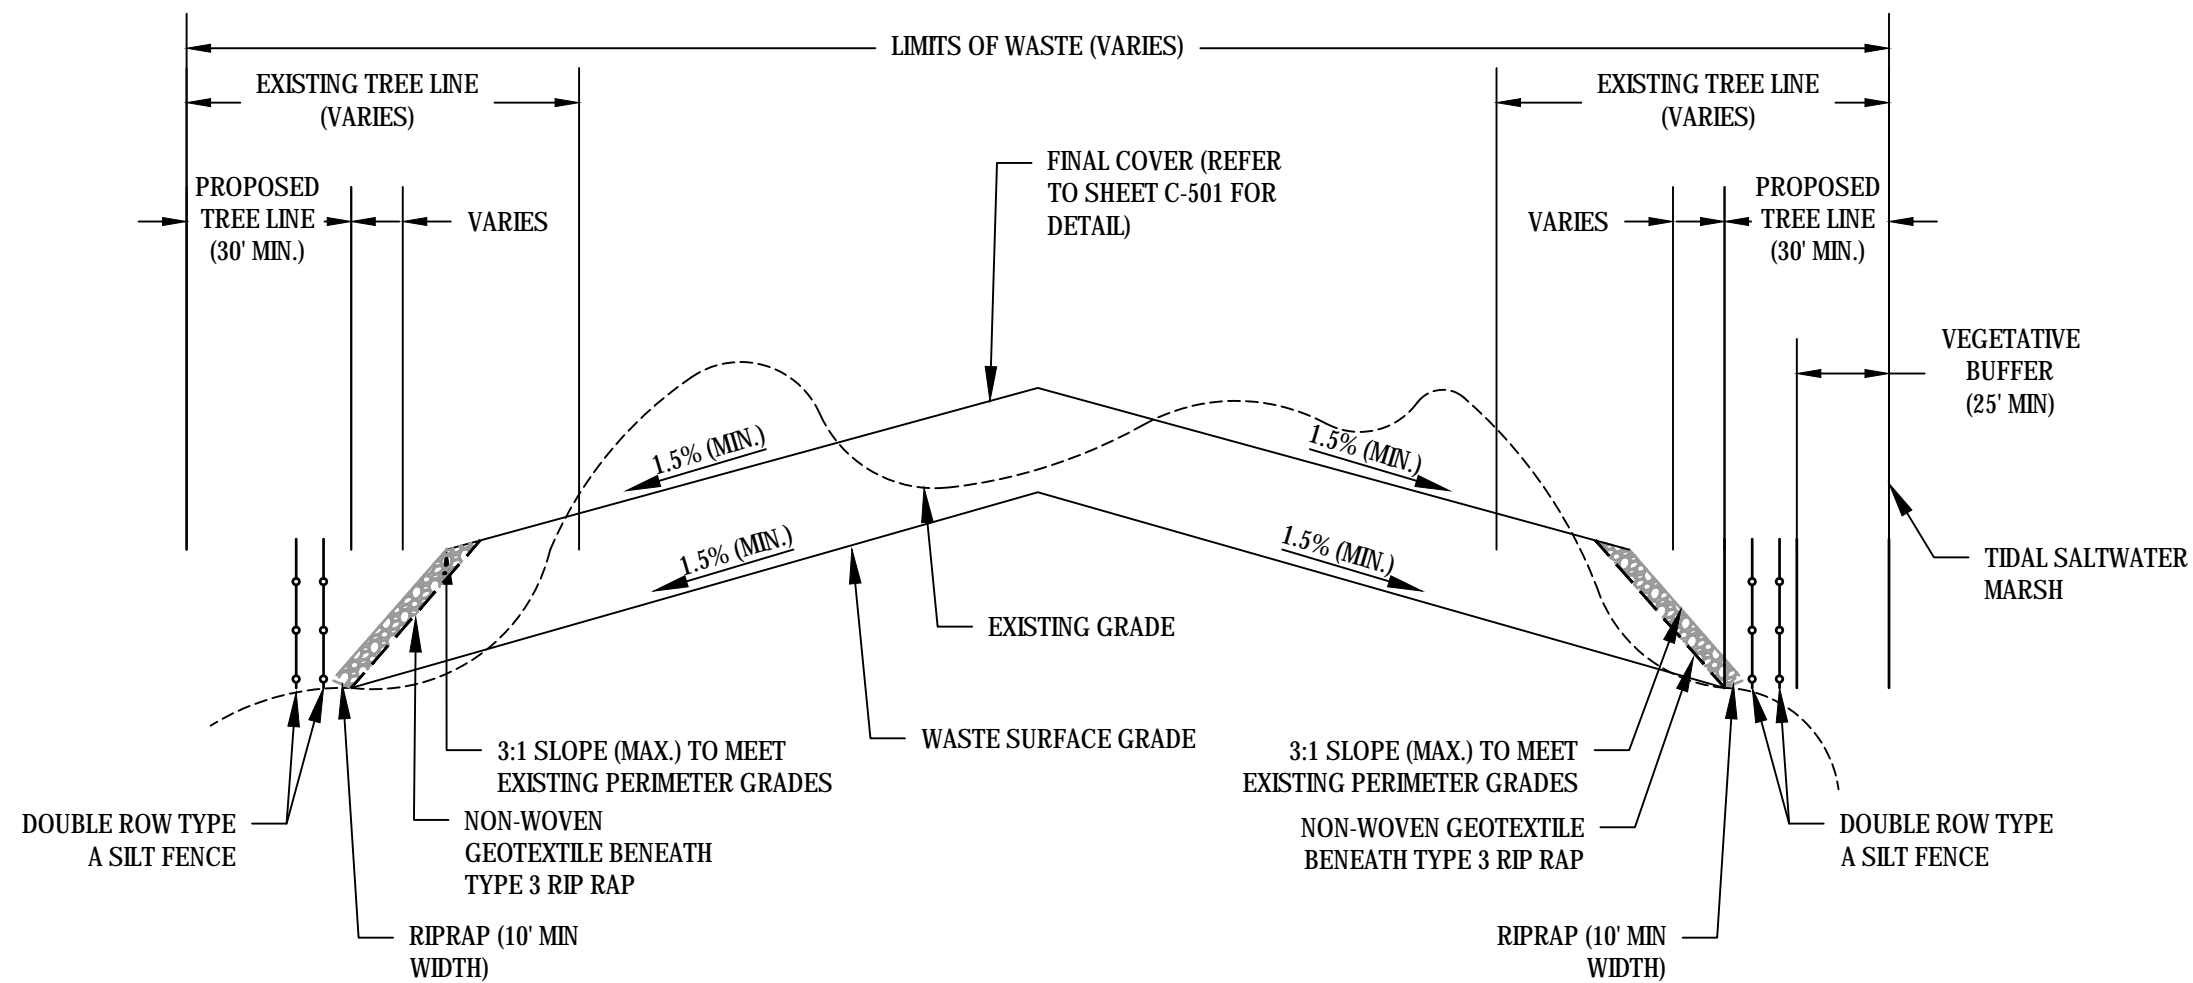C-501 N.T.S.




4 CROSS SECTION A-A

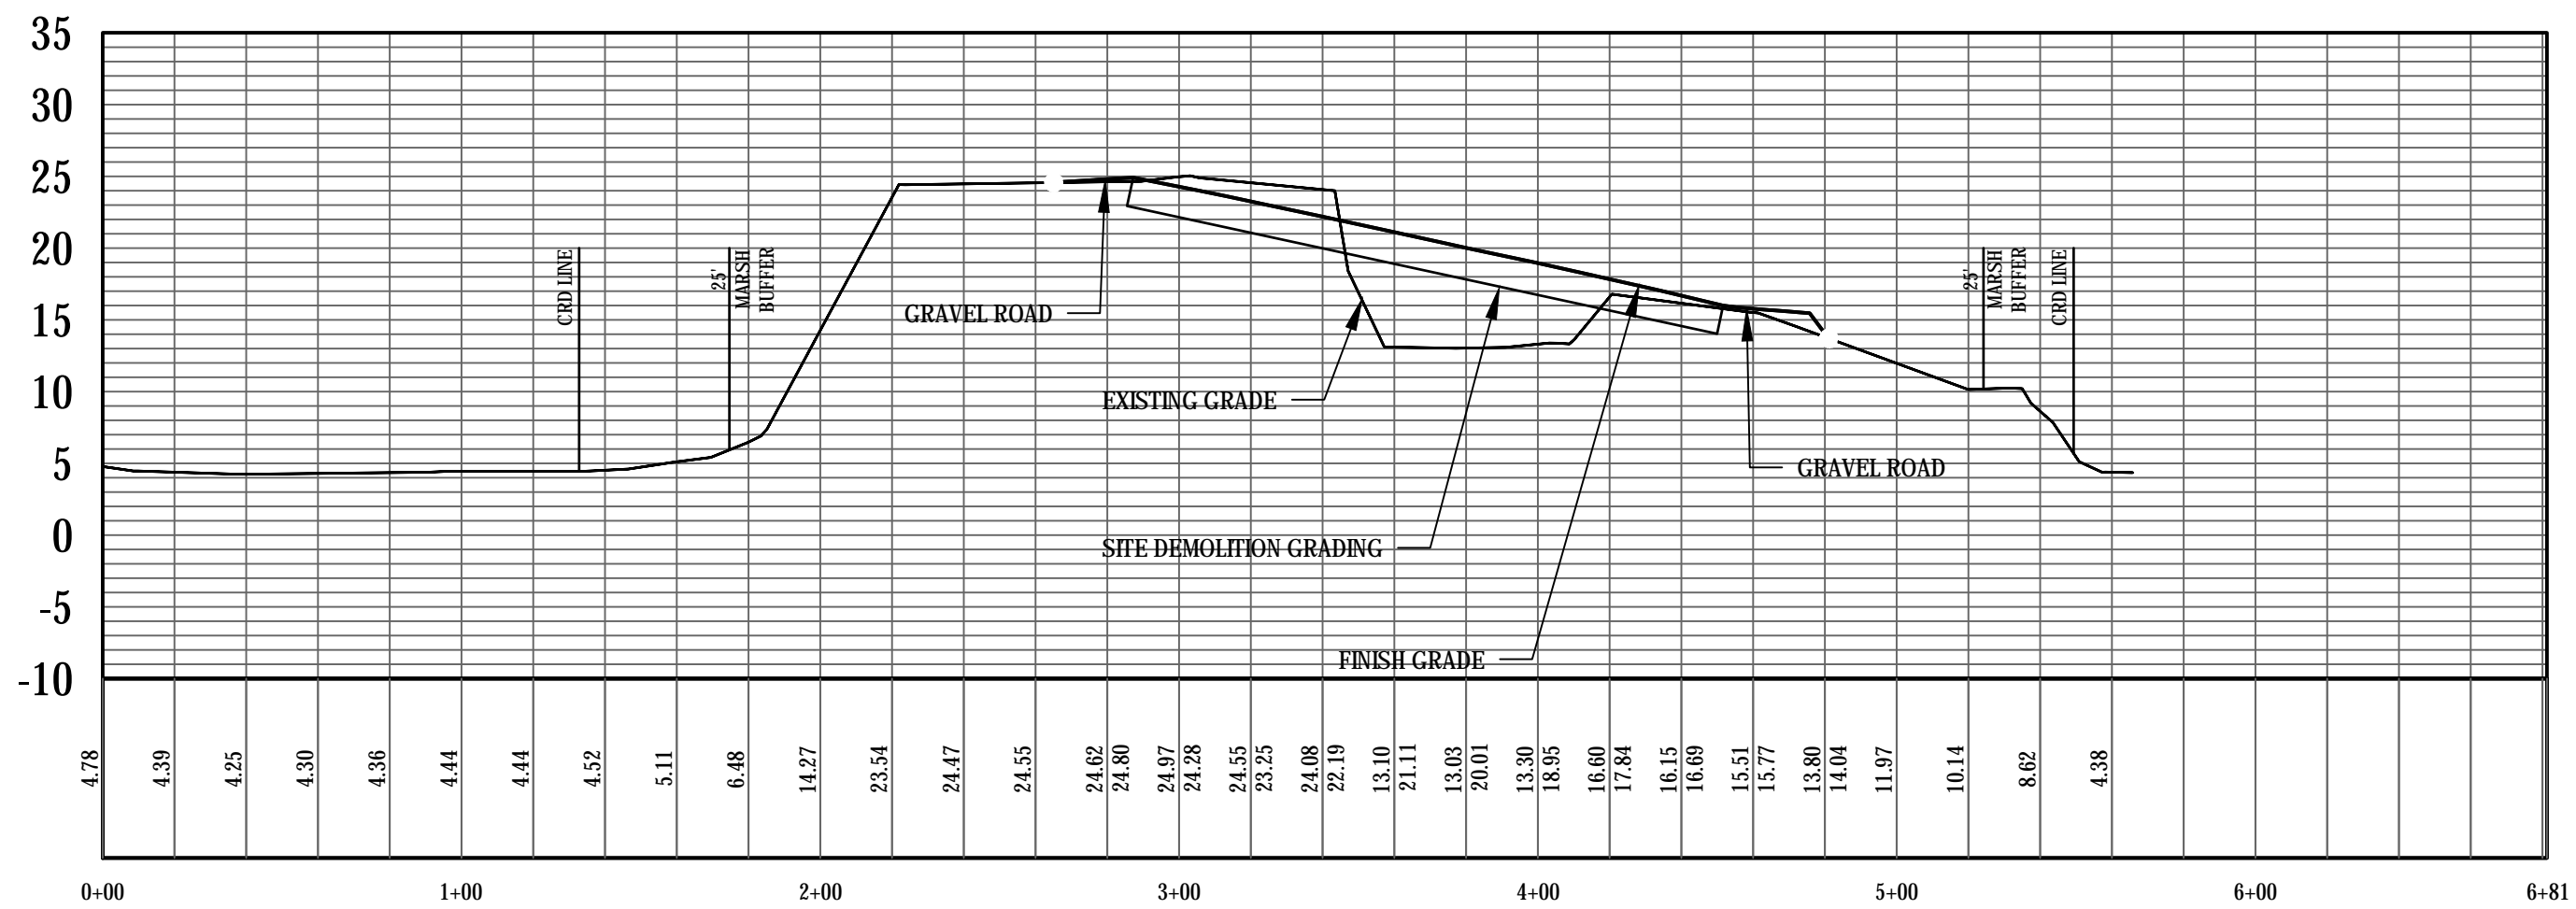C-501 V:1"=12.5 H:1"=50'




5 CROSS SECTION B-B

C-501 V:1"=12.5 H:1"=50'

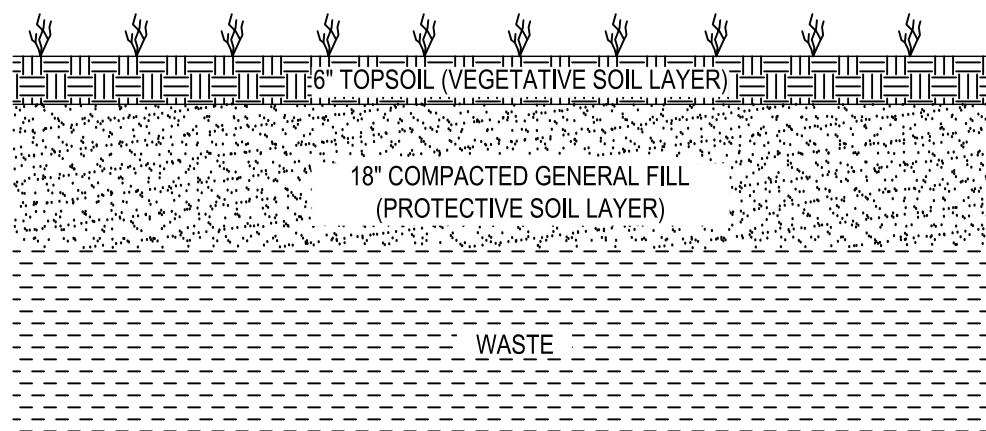


2 FINAL LANDFILL COVER DETAIL

C-501 N.T.S.

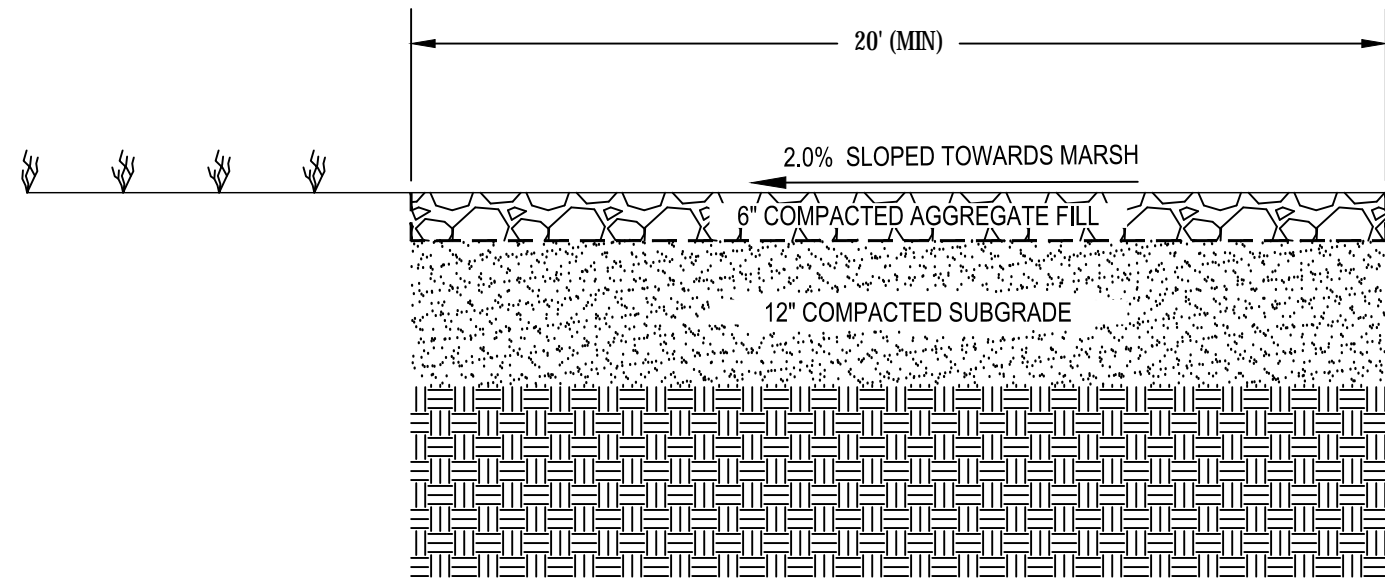

3 PERIMETER ACCESS ROAD DETAIL

C-501 N.T.S.

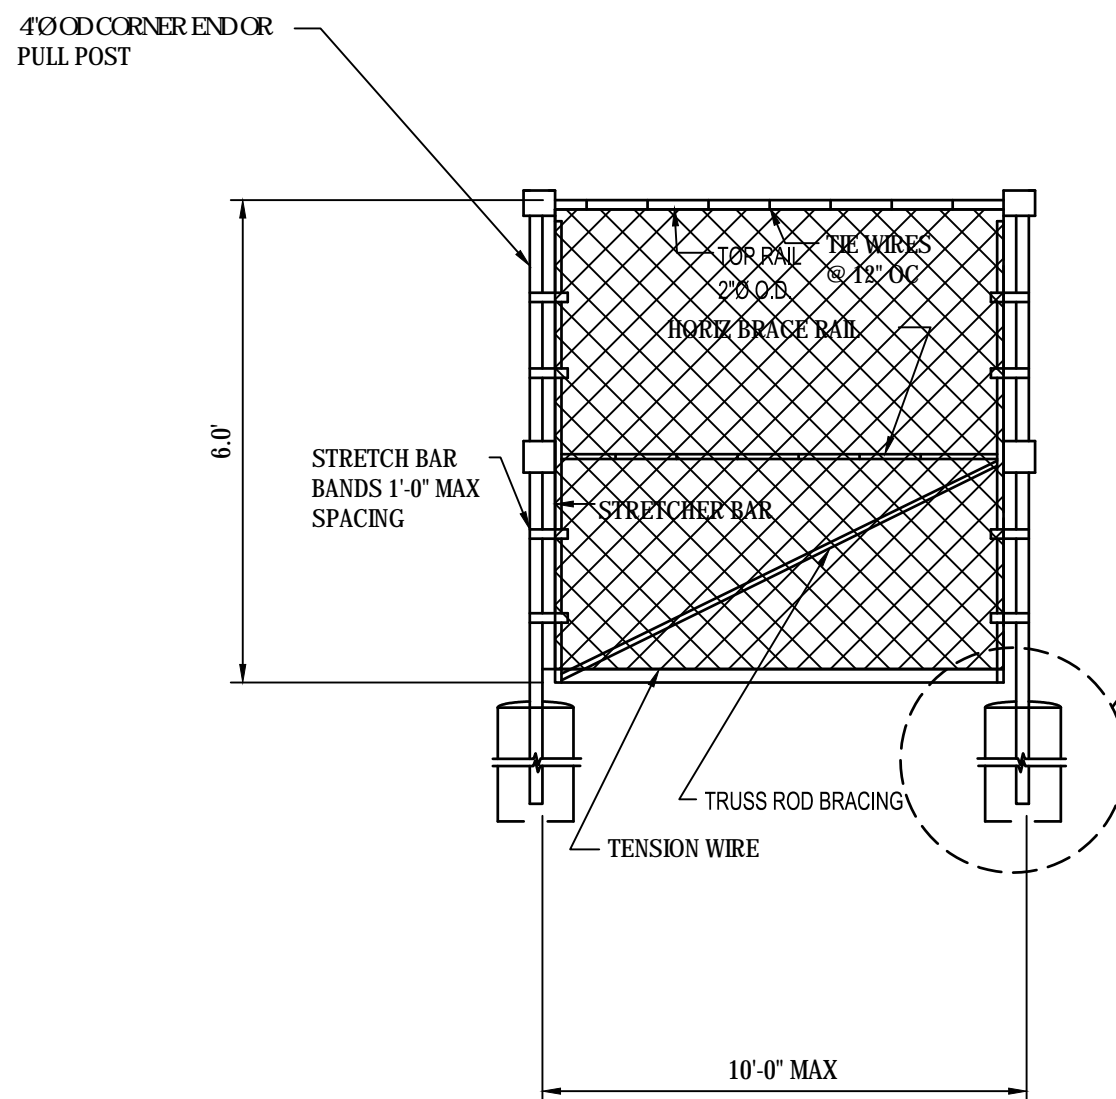

NOTE:


HORIZONTAL BRACE RAILS AND TRUSS ROD BRACING SHALL BE INSTALLED AT ALL CORNER, END, AND PULL POSTS. FABRIC SHALL BE FASTENED TO LINE POSTS AT NO MORE THAN 14" INTERVALS. TENSION WIRES SHALL BE TIED TO FABRIC WITH 9 GA. WIRE OR II GA. HOG RINGS AT INTERVALS OF 24" MAX.

6 CHAIN LINK FENCING DETAIL

C-501 N.T.S.



NO		DATE		REVISIONS		BY	AP.	NO	DATE	REVISIONS		BY	AP.	NOTICE		DWG. NO.	REFERENCE DRAWINGS		<i>T STREET LANDFILL CLOSURE</i>			ES&PC DETAILS															
														This drawing has not been published and is the sole property of T STREET LANDFILL STEERING GROUP and is lent to the borrower for their confidential use only; and in consideration of the loan of this drawing the borrower promises and agrees that it shall not be reproduced, copied, lent or otherwise disposed of directly or indirectly, nor used for any purpose other than for which it is specifically furnished.			GLYNN COUNTY BRUNSWICK, GA																				
0	20MAY20	ISSUED FOR CONSTRUCTION		LKR	PWM															ENG. LKR	JOB NO. 6123-20-1372	DATE 05/19/2020		6123-20-1372-C-501	----												
																			DR.	W. O.	DWG. NO.																
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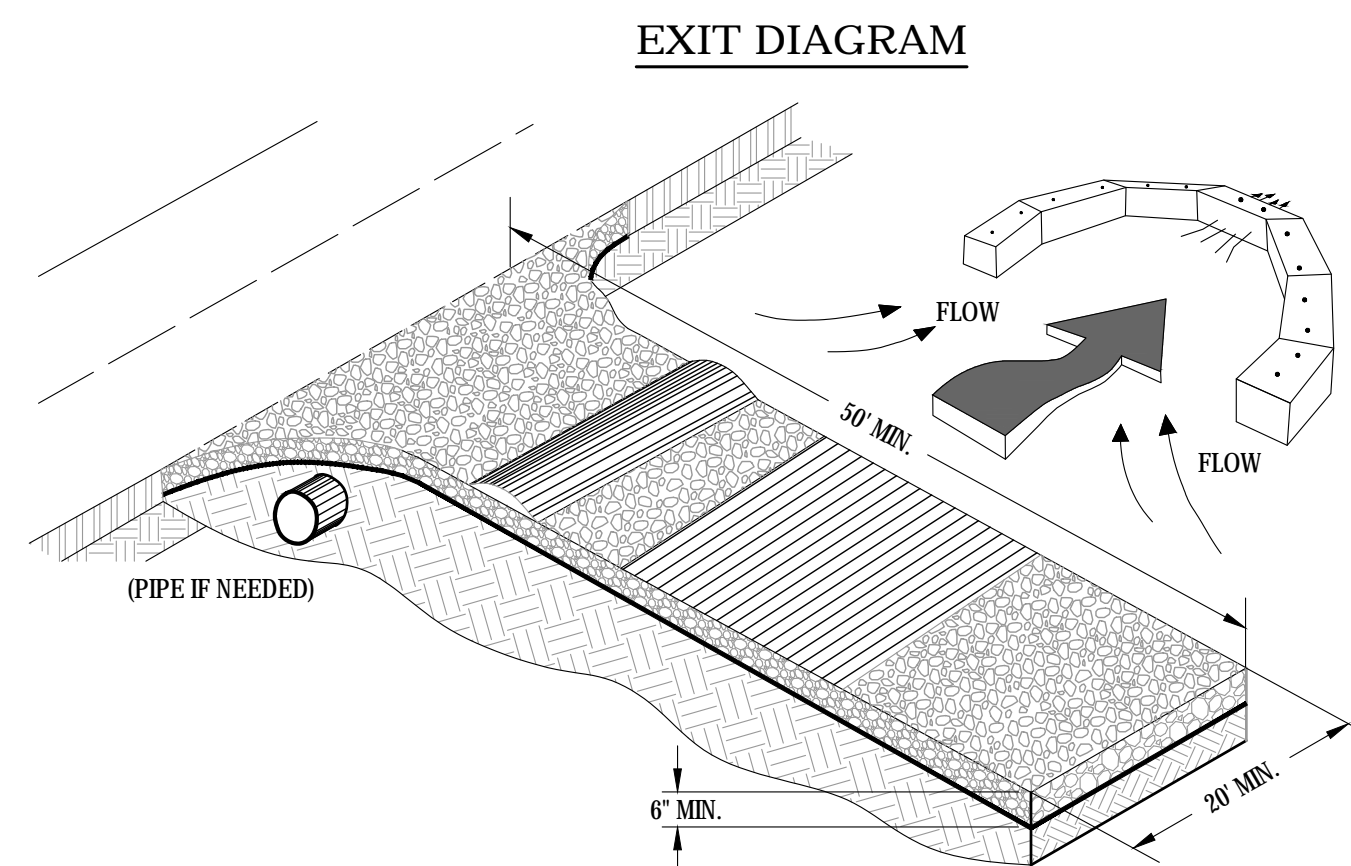
NOTES:

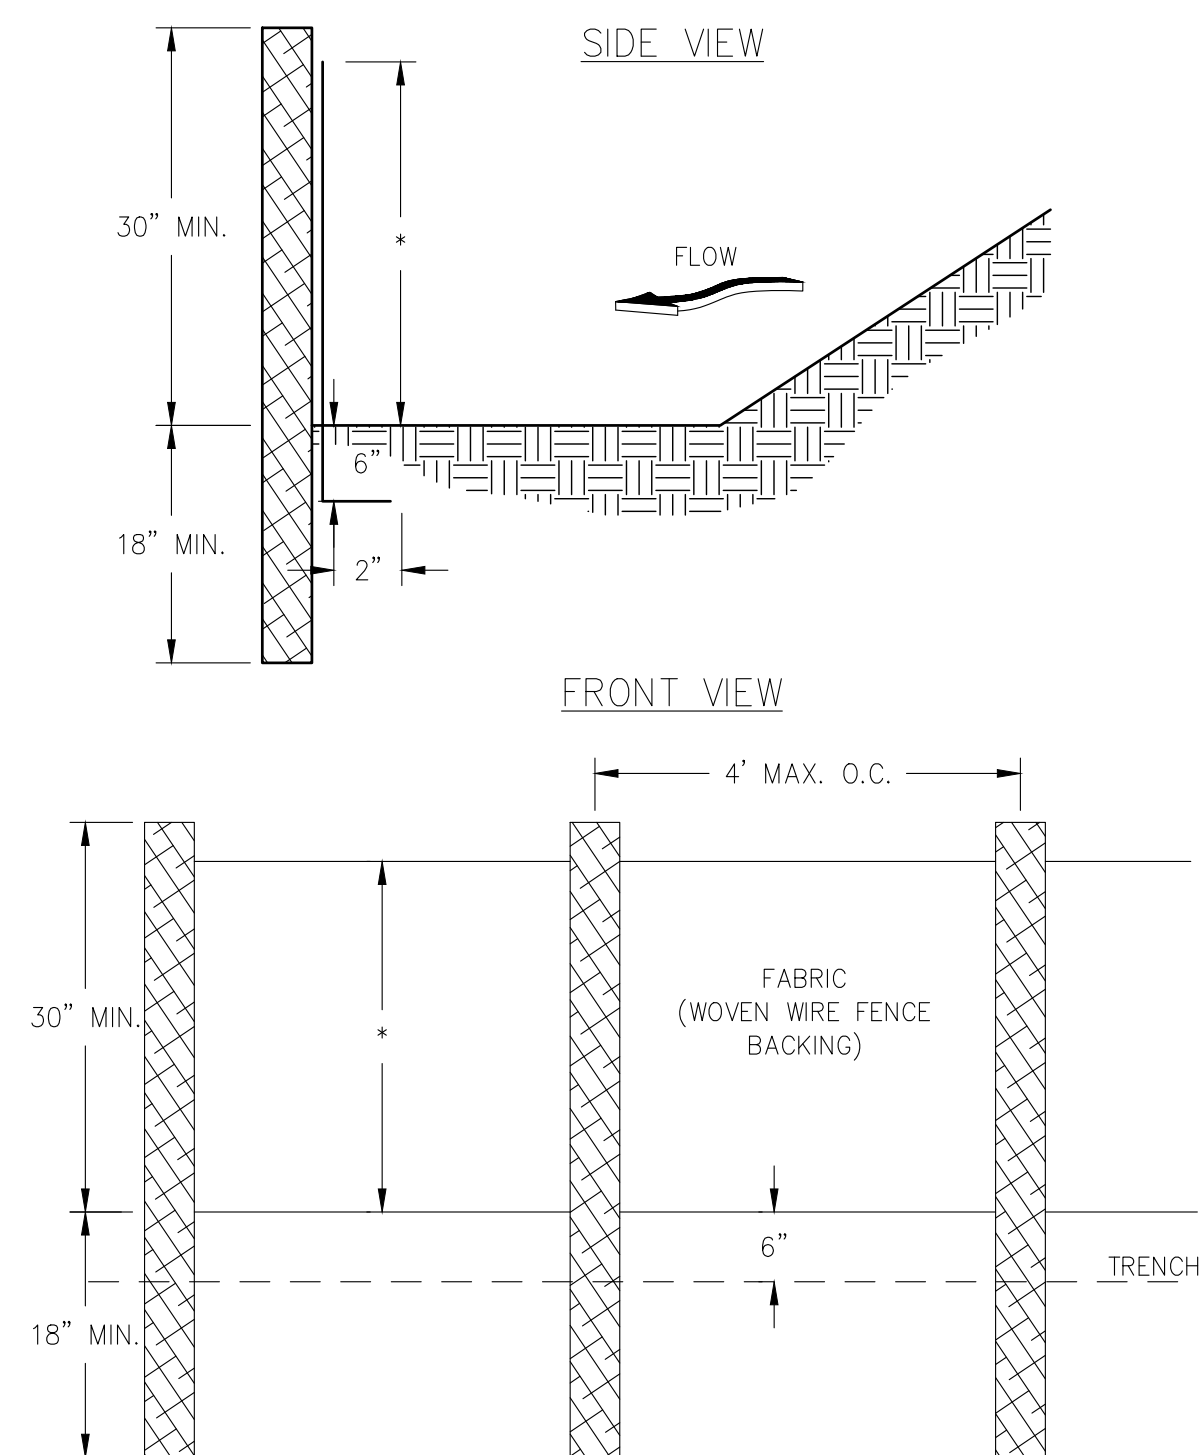1. USE STEEL OR WOOD POSTS OR AS SPECIFIED BY THE EROSION, SEDIMENTATION, AND POLLUTION CONTROL PLAN.
2. HEIGHT (*) IS TO BE SHOWN ON THE EROSION, SEDIMENTATION, AND POLLUTION CONTROL PLAN.


1
C-502 N.T.S.

SILT FENCE-TYPE SENSITIVE

Sd1-S



ENTRANCE ELEVATION

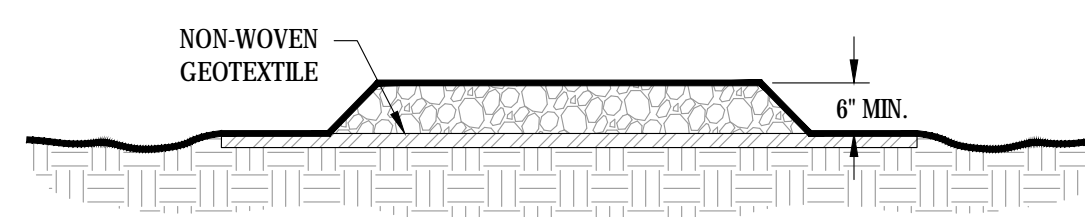


CRUSHED STONE CONSTRUCTION EXIT NOTES:

1. AVOID LOCATING ON STEEP SLOPES OR AT CURVES ON PUBLIC ROADS.
2. REMOVE ALL VEGETATION AND OTHER UNSUITABLE MATERIAL FROM THE FOUNDATION AREA, GRADE AND CROWN FOR POSITIVE DRAINAGE.
3. AGGREGATE SIZE SHALL BE IN ACCORDANCE WITH NATIONAL STONE ASSOCIATION R-2 (1.5"-3.5" STONE).
4. GRAVEL PAD SHALL HAVE A MINIMUM THICKNESS OF 6".
5. PAD WIDTH SHALL BE EQUAL FULL WIDTH AT ALL POINTS OF VEHICULAR EGRESS, BUT NO LESS THAN 20'.
6. A DIVERSION RIDGE SHOULD BE CONSTRUCTED WHEN GRADE TOWARD PAVED AREA IS GREATER THAN 2%.
7. INSTALL PIPE UNDER THE ENTRANCE IF NEEDED TO MAINTAIN DRAINAGE DITCHES.
8. WHEN WASHING IS REQUIRED, IT SHOULD BE DONE ON AN AREA STABILIZED WITH CRUSHED STONE THAT DRAINS INTO AN APPROVED SEDIMENT TRAP OR SEDIMENT BASIN (DIVERT ALL SURFACE RUNOFF AND DRAINAGE FROM THE ENTRANCE TO A SEDIMENT CONTROL DEVICE).
9. WASHRACKS AND/OR TIRE WASHERS MAY BE REQUIRED DEPENDING ON SCALE AND CIRCUMSTANCE. IF NECESSARY, WASHRACK DESIGN MAY CONSIST OF ANY MATERIAL SUITABLE FOR TRUCK TRAFFIC THAT WILL REMOVE MUD AND DIRT.
10. MAINTAIN AREA IN A WAY THAT PREVENTS TRACKING AND/OR FLOW OF MUD ONTO PUBLIC RIGHTS-OF-WAYS. THIS MAY REQUIRE TOP DRESSING, REPAIR AND/OR CLEANOUT OF ANY MEASURES USED TO TRAP SEDIMENT.

2 CRU
C-502 N.T.S.

CRUSHED STONE CONSTRUCTION EXIT

Co

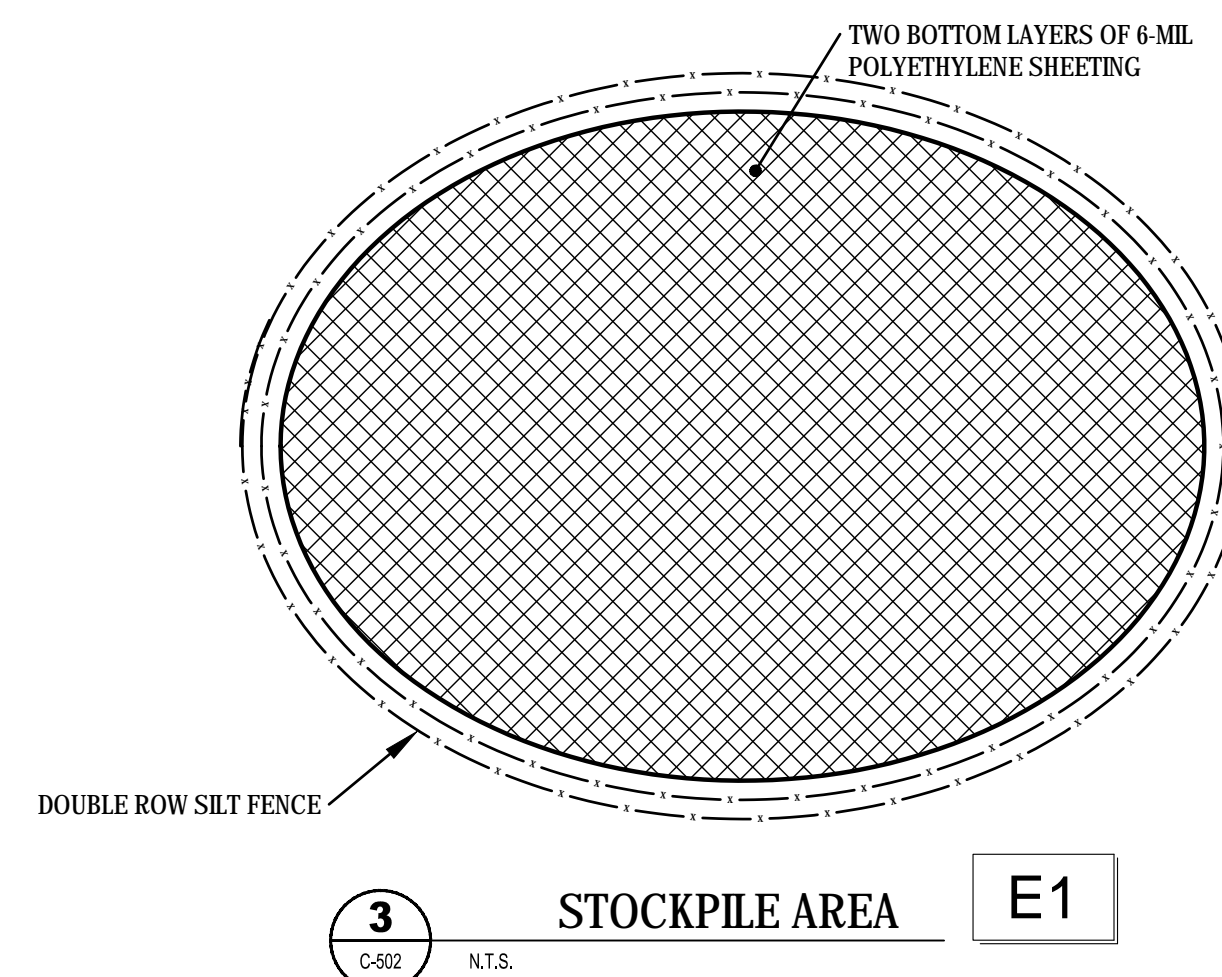

STOCKPILE AREA

E1



NO	DATE	REVISIONS	BY	AP.	NO	DATE	REVISIONS	BY	AP.	NOTICE			DWG. NO.	REFERENCE DRAWINGS			T STREET LANDFILL CLOSURE			ES&PC DETAILS			
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																		DR.	DWG. NO.	DWG. NO.	REV.		
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Technical Specifications



28 May 2020

T STREET LANDFILL CAP

PROJECT NUMBER 6123-19-1266
20MAY2020

Table of Contents

Section 2 Site Work

SW02102-001	Clearing and Grubbing
SW02110-001	Demolition
SW02200-001	Site Excavation and Backfill
SW02200-002	Earthwork
SW02210-001	Site Grading
Sw02213-001	Erosion and Sediment Control

Project Title:	T Street Landfill Closure				
Project #:	6123-19-1266				
Client:	T Street Landfill Steering Group				
Client #:					

APPROVAL STATUS					
PREPARED BY	Lauren Rainey, Project Engineer				May 20, 2020
	_____ Name, Title				_____ Date
REVIEWED BY:	Philip Marcum, Project Manager				May 20, 2020
	_____ Name, Title				_____ Date
ACCEPTED BY:	Philip Marcum, Project Manager				May 20, 2020
	_____ Name, Title				_____ Date

REVISION STATUS					
REV	ISSUED FOR	REVISED BY [LEAD]	CHECKED BY [DEPT]	APPROVAL [PROJ.MGR]	DATE [XX MONTH XXXX]
A	30% Submittal	LKR	GH	PWM	05MAY2020
0	100% Submittal	LKR	PWM	PWM	20MAY2020

PART 1 **GENERAL**

1.1 **DESCRIPTION**

- 1.1.1 Clear from site all trees and shrubs and brush within construction limits or as shown on plans. This should include removal of all roots and organic material below ground.

PART 2 **EXECUTION**

2.1 **CLEARING**

- 2.1.1 Clear the site of obstructions which in their present locations would interfere with construction. All items specifically noted on drawings to be removed or items which will be replaced with new construction shall be removed from site.
- 2.1.2 Landfill debris located within the existing wetlands or 25' protective buffer as shown on the plans shall be brought within the limits of the landfill closure project.
- 2.1.3 Remove trees, shrubs, brush, logs, stumps, and natural growth within the construction limits.
- 2.1.4 Remove all debris and spoil that will not be used during site regrading within 30 days of accumulation and dispose of offsite.

2.2 **PROTECTION**

- 2.2.1 Provide required batteries, warning signs and personnel to assure protection of roads, drives, utilities, adjacent sites and other work throughout time required to perform the work.
- 2.2.2 Preserve and protect from damage, any trees outside of construction limits.
- 2.2.3 Paint any cut or scarred trees and shrubs with asphaltum base tree paint.

2.3 **GRUBBING**

- 2.3.1 Remove all stumps, roots, and matted roots to a depth of 2' within the limits of grubbing.

2.4 **REMOVAL**

- 2.4.1 Remove all debris and spoil that will not be used during site regrading within 30 days of accumulation and dispose of offsite.
- 2.4.2 Burning of debris is not permitted.



PART 1 GENERAL

1.1 DESCRIPTION

1.1.1 The extent of the work is listed herein but not necessarily limited to the following:

- 1.1.1.1 Demolition and removal of designated structures, equipment, conveyor systems, trailers or metal structures.
- 1.1.1.2 Demolition and removal of foundations and slabs-on-grade.
- 1.1.1.3 Disconnection and removal of designated utilities.
- 1.1.1.4 Disconnection and removal of underground piping.
- 1.1.1.5 Disconnection and removal of designated chain link fences.
- 1.1.1.6 Disconnection and removal of totes, tanks, and containers.

1.2 SALVAGE

1.2.1 The following items shall be salvaged by the Contractor and suitably gathered and stored on the site for future use by the Owner – NONE.

1.3 PRECAUTIONS

- 1.3.1 Conduct demolition operations and the removal of debris to ensure minimum interference with adjacent roads.
- 1.3.2 Promptly repair damages caused to adjacent roads by demolition operations, as directed by the Construction Coordinator and at no cost to the Owner.
- 1.3.3 Maintain existing utilities not noted to be removed, in service and protect against damage during demolition.
- 1.3.4 Protect all site bench marks, monuments, witness post, stakes or survey features. Notify Construction Manager immediately if any survey features are disturbed or destroyed.

1.4 SCHEDULING AND COORDINATION

1.4.1 Coordination of scheduling for demolition activities will not be necessary as the landfill site is not operational.

1.5 CODES AND STANDARDS

1.5.1 Standard Unsafe Building Abatement Code and the International Building Code, latest edition.



- 1.5.2 Safety and Health Regulations of the U.S. Department of Labor, Occupational Safety and Health Administration.

PART 2 MATERIALS

2.1 DEMOLITION

- 2.1.1 All shoring, scaffolding, and other materials required for demolition work shall meet all of the strength and safety requirements of the above Codes and Regulations. No demolition is to proceed without shoring all items that would become unsafe if the work of this section were done.

PART 3 EXECUTION

3.1 DEMOLITION

- 3.1.1 Use water sprinkling, temporary enclosures and other suitable methods as necessary to limit the amount of dust and dirt rising and scattering in the air, to the lowest level of air pollution practical for the condition existing prior to the start of the work.
- 3.1.2 Remove from the site all debris, rubbish and other materials resulting from demolition operations. Storage or sale of removed materials will not be permitted on the site.
- 3.1.3 Maintain appropriate temporary erosion and sediment control measures.
- 3.1.4 Notify the owner's representative immediately if any hazardous, contaminated, or unknown materials are discovered; or if damage occurs to utilities not scheduled for removal.
- 3.1.5 Remove all items included in the demolition portion of the work completely with the limits established by the drawings, standards, and agreements established by the contract documents. All surfaces shall be left in a clean state.
- 3.1.6 All demolition debris shall be removed on a daily basis. Do not stockpile debris or material in the area of the project. All debris shall be disposed of according to owner's directions and standard procedures.
- 3.1.7 All demolition of asbestos containing material shall be done in accordance with government regulations and local standard procedures. All necessary forms and paperwork shall be initiated and submitted to the regulating bodies by the contractor. The contractor shall have the proper licenses and experience to do the asbestos abatement work of the project.
- 3.1.8 When demolition includes electrical components, all associated wiring and conduit shall also be removed.

**PART 1 GENERAL****1.1 SCOPE**

- 1.1.1 This work shall include excavation and backfill together with any required bedding materials, moisture control and compaction, disposal of excess excavated materials or providing additional fill material if required, and all subsidiary work necessary to complete the work to conform to the grades, lines and slopes shown on the drawings or, if not specified, restoration in kind of areas affected by construction.
- 1.1.2 Except where more specific or restrictive requirements are detailed on the drawings or specifically outlined in the scope section of this standard, the requirements in this standard are the basic minimums that shall apply to "The Work" as outlined in Section 2 of the General Conditions.

1.2 EXCAVATION

- 1.2.1 It is expected that the Contractor will encounter within the project bounds: ground water, soft spots, areas containing organic and non-compactable soils and possible minor underground obstructions in the excavation which are not shown on the drawings. Where these are of a minor nature and do not require equipment that would not be normally used for excavation operations or do not require substantial over excavation, they shall be removed without additional compensation.
- 1.2.2 Obstructions such as boulders over 3' in minor or least dimension, logs, concrete blocks or any other object requiring additional special equipment and labor for its removal shall be considered extra work unless specifically called out or identified on the drawings or in this standard.
- 1.2.3 All excavated materials not used in construction, materials designated as wasted excavation, or unsuitable materials shall be removed from the Owner's property.

1.3 OVER EXCAVATION AND/OR UNSUITABLE BACKFILL

- 1.3.1 Unsuitable excavated materials are generally considered to be organic and/or non-compactable materials and shall be selectively discarded prior to or during backfilling operations.
- 1.3.2 Any areas requiring over excavation, wasting of excavated material and backfilling with suitable material below regular designated subgrade requirements shall be extra work.
- 1.3.3 In the event there are inadequate quantities of reusable backfill derived from the required excavation, the quantities of approved fill material required to make up the deficiency and wasting of a comparable quantity of unsuitable materials shall be considered extra work. Excessive moisture content on otherwise suitable materials, whether natural or resulting from weather and construction procedures shall not be a basis for classification as unsuitable fill material.
- 1.3.4 The following limitations and conditions govern the extra work for over excavation or unsuitable fill conditions as described in subparagraphs B and C:
- 1.3.4.1 The work must be authorized by and as directed by the Owner's Representative.



- 1.3.4.2 The extra work shall not apply to known areas of unsuitable materials noted on the drawings or called out in the standards.

1.4 PUMPING

- 1.4.1 Pumping shall be provided by the Contractor at no additional expense to the Owner in order to keep all excavations free from water.

PART 2 MATERIALS

2.1 GENERAL

- 2.1.1 It shall be the Contractor's responsibility to provide materials well graded from coarse to fine that meet the required material gradation and standards.
- 2.1.2 At least 2 weeks before placing any fill, the Contractor shall notify the Owner as to the source of fill material. The Owner will check the source for compliance with the standards and also run tests as necessary to establish fill control curves.
- 2.1.3 The materials selected by the Contractor are subject to initial and continuing approval of the Owner's Representative.

PART 3 INSTALLATION

3.1 AREA SUB-GRADE APPROVAL AND FILL PLACEMENT

- 3.1.1 Prior to placing any fill on subgrade, the surface shall be proof-rolled by tracking with a sheep foot or tamping roller. Soft spots shall be removed and replaced with compacted backfill. See Article 1.2.2. Owner approval of subgrade is required prior to commencement of filling.

3.2 SOIL AND SUBGRADE COMPACTION REQUIREMENTS

- 3.2.1 The moisture content of materials involved in subgrade preparation and structural fill material shall be kept within the limits that will permit compaction meeting the requirements of this standard.
- 3.2.2 Unless more restrictive requirements are required by the drawings or in these standards, earthwork shall be compacted to at least 95% of maximum dry density as determined by ASTM D1557.
- 3.2.3 The compaction requirements shall include but are not necessarily limited to backfilling required for over excavated areas, subgrade preparation, road surface subgrades, subgrade for slope projection, etc.
- 3.2.4 The Owner or a representative from a testing service engaged by the Owner will field check soil compaction for compliance with standard requirements. If the average density of a lift is more than 2% below the required average, the lift will be immediately rejected.
- 3.2.5 If any tests indicate that the specified densities are not being obtained, the material shall be reworked, re-compacted and retested for compliance with these standards before the next lift is placed.