

Access Location

Sources: Esri, HERE, DeLorme, USGS, Intermap, INCREMENT P, NRCan, Esri Japan, METI, Esri China (Hong Kong), Esri Korea, Esri (Thailand), MapmyIndia, NGCC, © OpenStreetMap contributors, and the GIS User Community

| | |
|------------------|---------------------|
| RLC Project No.: | 17-124 |
| Figure No.: | 1 |
| Prepared By: | MG |
| Sketch Date: | 11/28/2017 |
| Map Scale: | 1 inch = 2,640 feet |

Beach Access Number 26
Glynn County, Georgia

GA DNR
NOV 30 2017

Project Location Map
Prepared For: Jim Broadwell

RESOURCE+LAND CONSULTANTS
41 Park of Commerce Way, Ste 303
Savannah, Georgia 31405
912.443.5896 www.rlc.com



RLC Project No.: 17-124
 Figure No.: 2
 Prepared By: MG
 Sketch Date: 11/28/2017
 Map Scale: 1 inch = 1,000 feet

**Beach Access
 Number 26**
 Glynn County, Georgia

GA DNR

**USGS Topographic
 Map**
 Prepared For: Jim Broadwell



**RESOURCE+LAND
 CONSULTANTS**
 41 Park of Commerce Way, Ste 303
 Savannah, Georgia 31405
 912.443.5896 www.rland.com



Access Location

Sources: Esri, DigitalGlobe, GeoEye, Earthstar Geographics, CNES/Airbus DS, USDA, USGS, AeroGRID, IGN, and the GIS User Community



| | |
|------------------|-------------------|
| RLC Project No.: | 17-124 |
| Figure No.: | 3 |
| Prepared By: | MG |
| Sketch Date: | 11/28/2017 |
| Map Scale: | 1 inch = 100 feet |

Beach Access Number 26
Glynn County, Georgia

GA DNR

Ortho Aerial Map
Prepared For: Jim Broadwell

RLC

RESOURCE+LAND CONSULTANTS
41 Park of Commerce Way, Ste 303
Savannah, Georgia 31405
912.443.5896 www.rlandc.com

11/28/2017



GA DNR

NOV 30 2017


Marsh & Shore Mgt. Program

AERIAL SITE PLAN
SCALE: NONE

NOTE: THIS DRAWING IS FOR INFORMATION ONLY. ALL DIMENSIONS & JURISDICTION LINES SHOWN ARE APPROXIMATE & BASED ON SURVEY BY SHARP SURVEYING CO. DATE: 10/01-11/01/16 (REV) 11/22/16.




| | | | | | |
|------------------|-------------------------------------------------------------------------------------------------|------------------------------|----------|--------------------------------------------------------------------|-------------------------|
| DWG. BY: JAN | PT-TECH, INC. 3086 CYPRESS AVE., 2D MARIETTA, GA 30067 404.875.2200 www.pt-tech.com | PINE ISLAND AUTHORITY | Tech | ACCESS MODIFICATIONS & RAMP BEACH ACCESS #26 PINE ISLAND, GA | SHEET NO. |
| CHK. BY: DESA | DATE: 11/7/17 | | | | SCALE: NONE UNCL. |

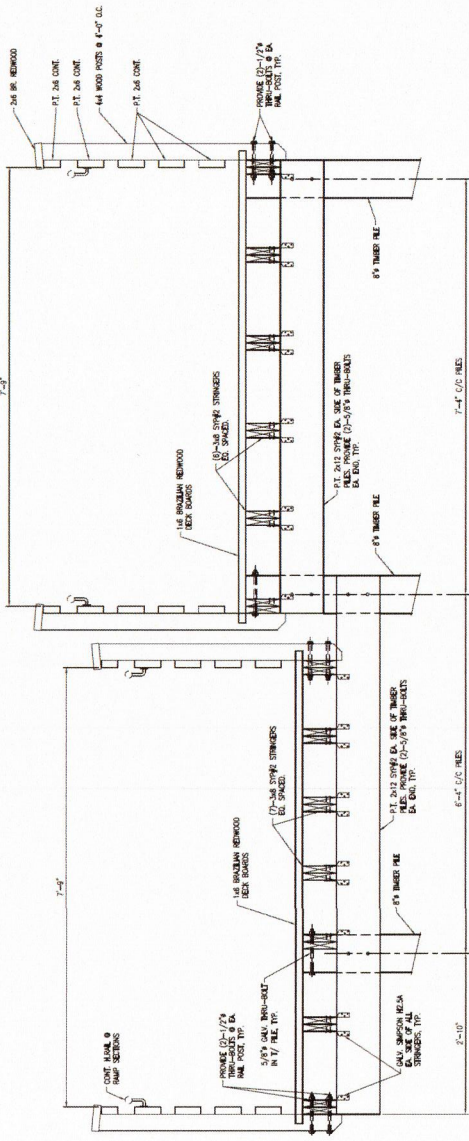

A
TYPICAL SECTION — RAMP ADDITION
SCALE 1" = 1'-0"

C
TYPICAL SECTION — DUNE CROSSOVER
SCALE 1" = 1'-0"

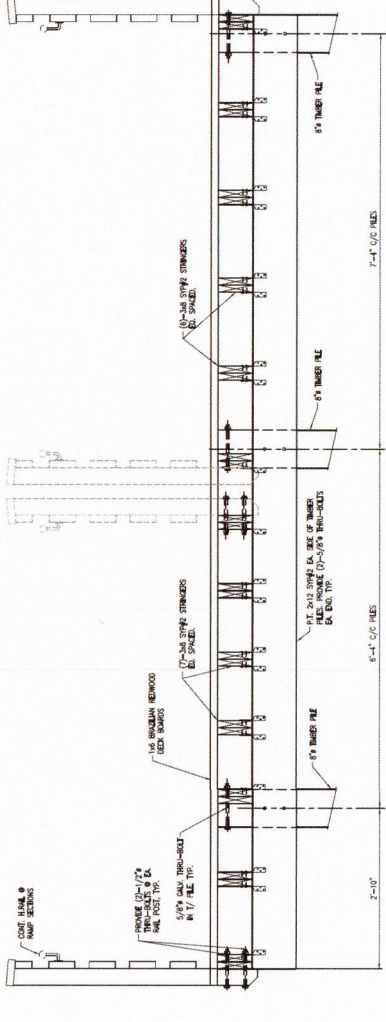

B
TYPICAL SECTION — RAMP ADDITION LANDING
SCALE 1" = 1'-0"

D
TYPICAL SECTION — CONNECTOR
SCALE 1" = 1'-0"

GA DNR

NOV 30 2017

Marsh & Shore Mgt. Program



YEMALLI ISLAND
AUTHORITY

PI-TECH, INC.
13345 CYPRESS HILL RD
HOUSTON, TX 77060
www.pi-tech.com

PROJECT NO.
S2.0
SHEET 2 OF 2

ACCESS MODIFICATIONS & RAMP
BRANCH ACCESS #26
JERTILL ISLAND, GA

DATE: 11/2/17
SCALE: 1" = 1'-0"
UNO.

- WOOD FRAMING NOTES:**
1. WOOD FRAMING SHALL BE INSTALLED PER INTERNATIONAL BUILDING CODE (IBC), 2012 EDITION, & NATIONAL DESIGN SPECIFICATION, 2010 EDITION.
 2. ALL LUMBER SHALL BE DRY KILN DRIED TO A MAXIMUM MOISTURE CONTENT OF 19%.
 3. ALL LUMBER SHALL BE GRADE-MATCHED TO BE CONSISTENT WITH THE DESIGN.
 4. ALL LUMBER SHALL BE GRADE-MATCHED TO BE CONSISTENT WITH THE DESIGN.
 5. ALL LUMBER SHALL BE GRADE-MATCHED TO BE CONSISTENT WITH THE DESIGN.
 6. ALL LUMBER SHALL BE GRADE-MATCHED TO BE CONSISTENT WITH THE DESIGN.


- TIMBER PILE NOTES:**
1. NEW TIMBER PILES SHALL CONFORM TO ASTM D245, SA-YELLOW PINE, 4/4" DIA. OR EQUIVALENT.
 2. PILES SHALL BE DRIVEN IN ACCORDANCE WITH THE AMERICAN PILE DRIVING ASSOCIATION (APDA) STANDARD PRACTICES FOR PILE DRIVING.
 3. ALL NEW TIMBER PILES SHALL BE INSTALLED AT AN ANGLE OF 90 DEGREES TO THE LONG AXIS OF THE PILE.
 4. PILES SHALL BE DRIVEN TO A MINIMUM PENETRATION OF 30 FEET INTO THE SOIL.
 5. PILES SHALL BE DRIVEN TO A MINIMUM PENETRATION OF 30 FEET INTO THE SOIL.
 6. PILES SHALL BE DRIVEN TO A MINIMUM PENETRATION OF 30 FEET INTO THE SOIL.

- GENERAL NOTES:**
1. ALL DIMENSIONS ARE APPROXIMATE.
 2. ALL DIMENSIONS ARE APPROXIMATE.
 3. ALL DIMENSIONS ARE APPROXIMATE.
 4. ALL DIMENSIONS ARE APPROXIMATE.
 5. ALL DIMENSIONS ARE APPROXIMATE.
 6. ALL DIMENSIONS ARE APPROXIMATE.

- EXISTING CROSSOVER MODIFICATION NOTES:**
1. EXISTING CROSSOVER SHALL BE MAINTAINED AS SHOWN.
 2. EXISTING CROSSOVER SHALL BE MAINTAINED AS SHOWN.
 3. EXISTING CROSSOVER SHALL BE MAINTAINED AS SHOWN.
 4. EXISTING CROSSOVER SHALL BE MAINTAINED AS SHOWN.
 5. EXISTING CROSSOVER SHALL BE MAINTAINED AS SHOWN.
 6. EXISTING CROSSOVER SHALL BE MAINTAINED AS SHOWN.

NOTE: ALL DIMENSIONS ARE APPROXIMATE. VERIFY ALL DIMENSIONS AND CONDITIONS IN THE FIELD PRIOR TO CONSTRUCTION.

NOTE: ALL DIMENSIONS ARE APPROXIMATE. VERIFY ALL DIMENSIONS AND CONDITIONS IN THE FIELD PRIOR TO CONSTRUCTION.

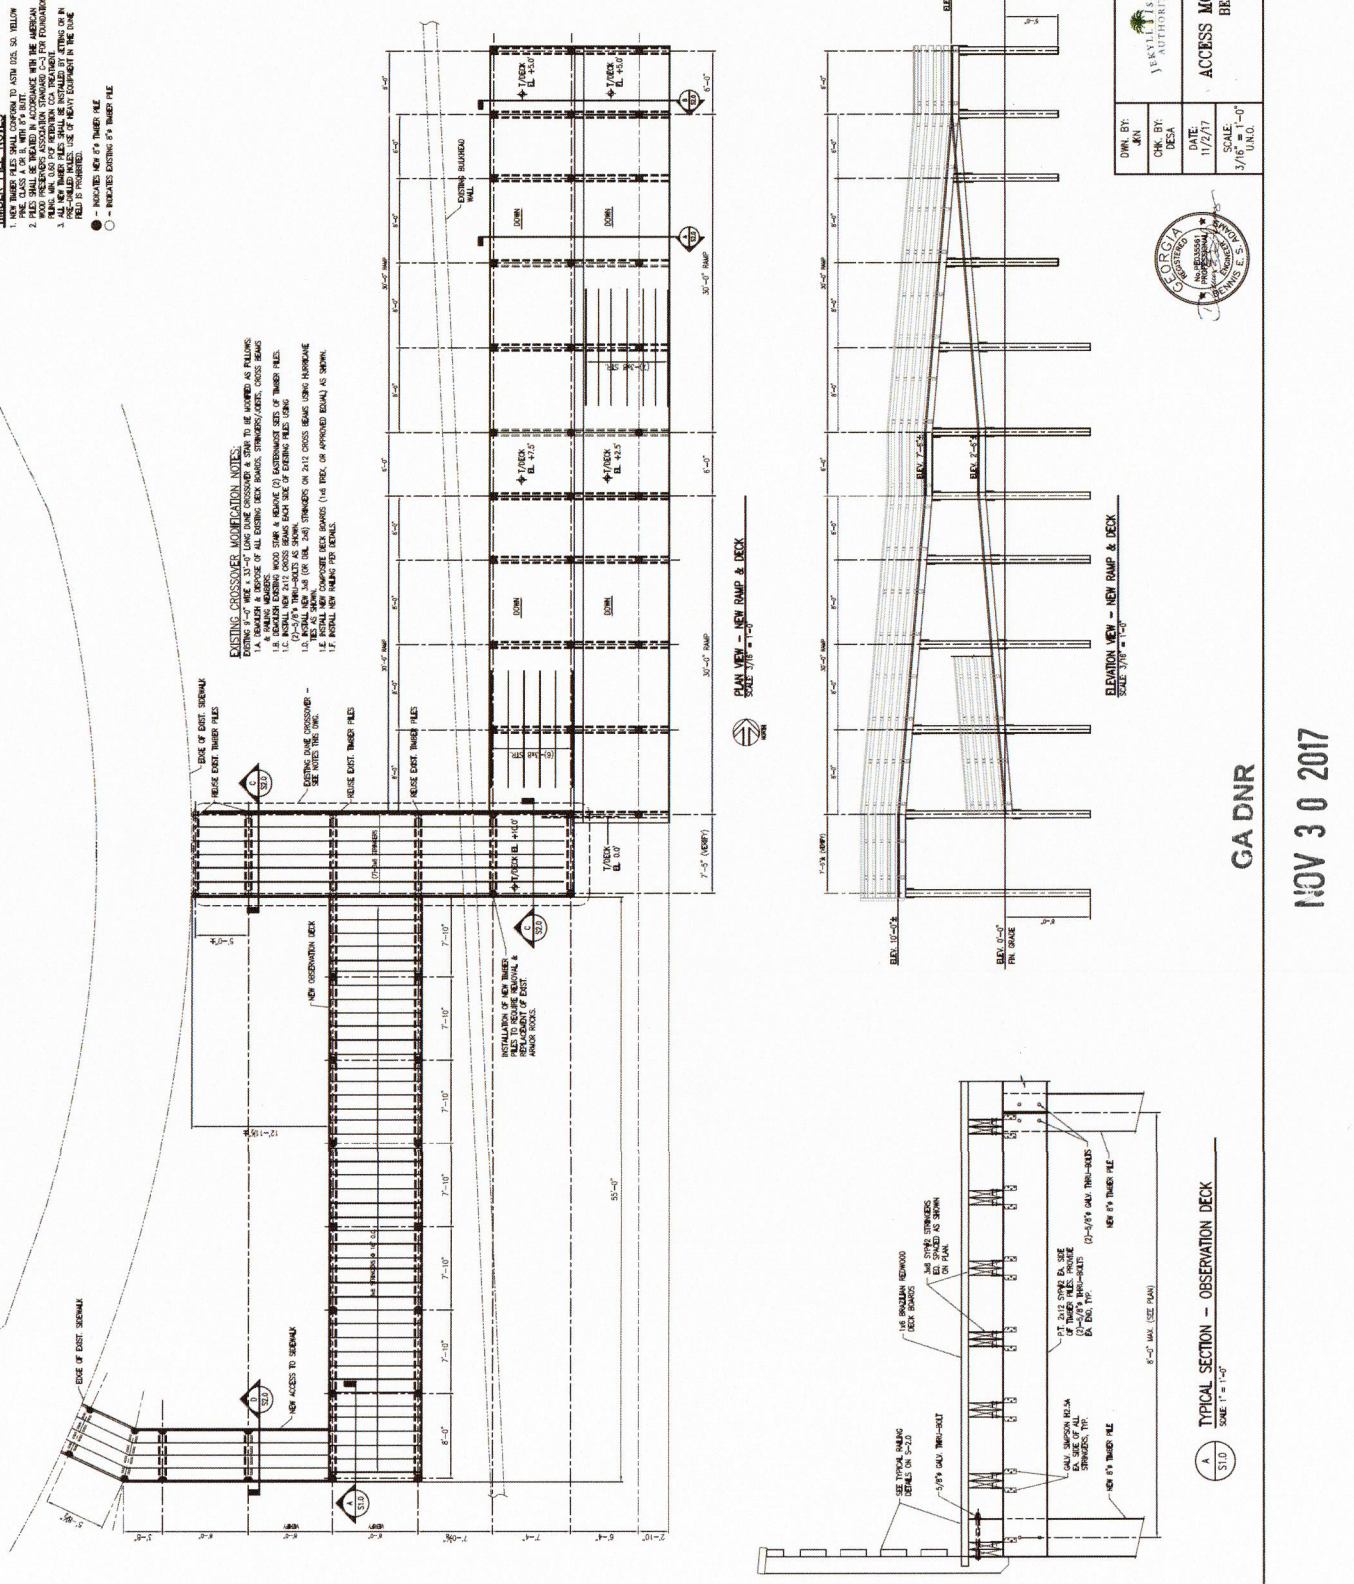

TYPICAL SECTION - OBSERVATION DECK
SCALE: 1" = 1'-0"

ELEVATION VIEW - NEW RAMP & DECK
SCALE: 1/8" = 1'-0"

GA DNR

NOV 30 2017

Marsh & Shore Mgt. Program

PI-TECH, INC.
3800
MOUNTAINVIEW, GA 31400
www.pi-tech.com



PERMIT AUTHORITY
SHELLY ISLAND

PROJECT NO. S1.0
SHEET 1 OF 2
ACCESS MODIFICATIONS & RAMP
BRANCH ACCESS #28
RETAIL ISLAND, GA



DATE: 11/27/17
SCALE: 3/16" = 1'-0"

CHK BY: DESA
APP. BY: J.M. [Signature]